

ORDINANCE NO. _____

AN ORDINANCE OF THE CITY OF DENTON, TEXAS, APPROVING A SPECIFIC USE PERMIT FOR A MULTI-FAMILY RESIDENTIAL USE ON APPROXIMATELY 32.60 ACRES AND TO ALLOW FOR AN OUTDOOR RECREATION USE ON APPROXIMATELY 19.90 ACRES. THE PROPERTY IS GENERALLY LOCATED ON THE SOUTH SIDE OF WEST OAK STREET APPROXIMATELY 290 FEET WEST OF THE INTERSTATE HIGHWAY 35 SERVICE ROAD IN THE CITY OF DENTON, DENTON COUNTY, TEXAS; PROVIDING FOR A PENALTY IN THE MAXIMUM AMOUNT OF \$2,000.00 FOR VIOLATIONS THEREOF; PROVIDING A SEVERABILITY CLAUSE AND AN EFFECTIVE DATE. (S17-0009)

WHEREAS, Rayzor Investments Ltd. has applied for a Specific Use Permit (SUP) to allow for a multi-family residential use on approximately 32.60 acres and to allow for an outdoor recreation use on approximately 19.90 acres, within the NRMU zoning district and use classification, said total acreage is composed of lots legally described and the location of which is shown in **Exhibit A**, attached hereto and incorporated by reference herein (the "Property"); and

WHEREAS, after notice was published, a public hearing was held before the Planning and Zoning Commission in accordance with State law on November 8, 2017, whereby the Planning and Zoning Commission recommended approval (4-3) of the requested SUP, subject to conditions; and

WHEREAS, on December 5, 2017, after notice published, a public hearing was held before the City Council in accordance with State law and the City Council hereby finds that the request is consistent with the Denton Plan and federal, state, and local law and that the Applicant has agreed to comply with all provisions of the Denton Development Code, as they exist, may be amended, or in the future arising, including but not limited to, this Ordinance, and has further agreed to comply with the additional restrictions and conditions set forth herein; and

WHEREAS, the City Council has determined that it will be beneficial to Denton and its citizens to grant the SUP; that such grant will not be detrimental to the public welfare, safety, or health; and that the SUP should be granted; NOW THEREFORE,

THE COUNCIL OF THE CITY OF DENTON HEREBY ORDAINS:

SECTION 1. The findings and recitations contained in the preamble of this ordinance are incorporated herein by reference and found to be true.

SECTION 2. The SUP to allow the multi-family and outdoor recreation uses on the Property is hereby approved, subject to the following conditions:

1. The provided Site Plan, Landscape Plan, and Building Elevations shown in **Exhibit B** are conceptual. A full site plan submittal shall be required to ensure each phase of the development complies with the requirements of the Denton Development Code in terms of site design, landscaping, parking, and building design as provided in DDC 35.6.3.
2. A full assessment of the Environmentally Sensitive Areas (ESA) on the property is required and an Alternative ESA plan must be approved before any development within the boundaries of the ESA shown on the Conceptual Site Plan can be approved.
3. The development of a multi-family use shall be limited to the 32.6 acres designated for this use on the attached Conceptual Site Plan, and an outdoor recreation use shall be limited to the 19.9 acres indicated for this use on the attached conceptual Site Plan. The multi-family use shall contain no more than the 289 units shown on the conceptual Site Plan and the density of development shall be calculated based on only the area within each proposed phase of the multi-family development.

SECTION 3. Failure to Comply. Except as otherwise stated above, all terms of the SUP shall be complied with prior to issuance of a Certificate of Occupancy. Failure to comply with any term or condition of the Ordinance will result in the SUP being declared null and void and of no force and effect. The SUP is issued to the entity named above and is assignable and transferable.

SECTION 4. SUP Regulations. Upon notice to the property owner and a hearing before the City Council, a SUP may be revoked or modified if: 1. There is one or more of the conditions imposed by this Ordinance that has not been met or has been violated on the Property; or 2. The SUP was obtained or extended by fraud or deception; or 3. As otherwise permitted by law and/or Denton's Zoning Ordinance.

SECTION 5. Unlawful use. It shall be unlawful for any person, firm, entity, or corporation to make use of the above-referenced Property in some manner other than as authorized by the Denton Code of Ordinances and this Ordinance.

SECTION 6. Severability. If any provision of this ordinance or the application thereof to any person or circumstance is held invalid by any court, such invalidity shall affect the validity of the provisions or applications, and to this end the provisions of this ordinance are severable.

SECTION 7. Penalty. Any person, firm, entity or corporation violating any provision of this ordinance shall, upon conviction, be fined a sum not exceeding \$2,000.00 for each violation. Each day that a provision of this ordinance is violated shall constitute a separate and distinct offense. The penal provisions imposed under this Ordinance shall not preclude Denton from filing suit to enjoin the violation and it retains all legal rights and remedies available to it under local, state and federal law.

SECTION 8. Effective Date. This ordinance shall become effective fourteen (14) days from the date of its passage, and the City Secretary is hereby directed to cause the caption of this ordinance to be published twice in the Denton Record-Chronicle, a daily newspaper published in the City of Denton, Texas, within ten (10) days of the date of its passage.

PASSED AND APPROVED this the _____ day of _____, 2017.

CHRIS WATTS, MAYOR

ATTEST:
JENNIFER WALTERS, CITY SECRETARY

BY: _____

APPROVED AS TO LEGAL FORM:
AARON LEAL, CITY ATTORNEY

BY:  _____

Exhibit A

LEGAL DESCRIPTION

71.76 ACRES

BEING a tract of land situated in the Eugene Puchalski Survey, Abstract No. 996, City of Denton, Denton County, Texas, and being part of "Section 3" "TRACT TWO" and "TRACT THREE" described in Special Warranty Deed to Jess Newton Rayzor, the Estate of Sewyn Rayzor Singleton, Evelyn Rayzor Neinhuis, and June Rayzor Elliott recorded in Volume 1796, Page 601 Deed Records of Denton County, Texas, and being all of those tracts of land described in Warranty Deeds to RAYZOR INVESTMENTS, LTD., recorded in Instrument Nos. 2007-20903 & 2007-20904, Official Records of Denton County, Texas and being more particularly described as follows:

BEGINNING at a point in the north right-of-way line of Precision Drive (a 70-foot wide right-of-way), and being the southeast corner of Lot 10, Block A, Westpark Addition, Phase 2, an addition to the City of Denton, Texas according to the plat recorded in Document No. 2013-318 of the Plat Records of Denton County, Texas;

THENCE with the east line of said Lot 10, the following courses and distances:

North 7°12'15" East, a distance of 102.26 feet to a point at the beginning of a tangent curve to the left having a central angle of 19°29'54", a radius of 512.50 feet, a chord bearing and distance of North 2°32'42" West, 173.57 feet;
 In a northwesterly direction, with said curve to the left, an arc distance of 174.41 feet to a point for corner;
 North 12°17'40" West, a distance of 145.70 feet to a point at the beginning of a tangent curve to the right having a central angle of 12°45'12", a radius of 537.50 feet, a chord bearing and distance of North 5°55'04" West, 119.39 feet;
 In a northwesterly direction, with said curve to the right, an arc distance of 119.64 feet to a point for corner;
 North 0°27'30" East, a distance of 1355.70 feet to a point at the beginning of a tangent curve to the right having a central angle of 21°52'47", a radius of 536.50 feet, a chord bearing and distance of North 11°23'54" East, 203.63 feet;
 In a northeasterly direction, with said curve to the right, an arc distance of 204.88 feet to a point for corner;
 North 22°20'17" East, a distance of 159.02 feet to a point in the south right-of-way line of West Oak Street (an 80-foot wide right-of-way) and being at the beginning of a non-tangent curve to the left having a central angle of 47°17'08", a radius of 790.00 feet, a chord bearing and distance of South 88°39'24" East, 633.63 feet;


THENCE with said south right-of-way line of West Oak Street, the following courses and distances:

In a southeasterly direction, with said curve to the left, an arc distance of 651.98 feet to a point for corner;
 North 67°42'01" East, a distance of 225.02 feet to a point for corner at the intersection of said south right-of-way line of West Oak Street and the west right-of-way line of the Kansas City Southern Railroad;

CONTINUED ON SHEET 2

EXHIBIT
 71.76 ACRES
 EUGENE PUCHALSKI SURVEY,
 ABSTRACT NO. 996
 CITY OF DENTON, DENTON COUNTY, TEXAS

J. ANDY DOBBS
 REGISTERED PROFESSIONAL
 LAND SURVEYOR NO. 6196
 12750 MERIT DRIVE, SUITE 1000
 DALLAS, TEXAS 75251
 PH. 972-770-1300
 andy.dobbs@kimley-horn.com

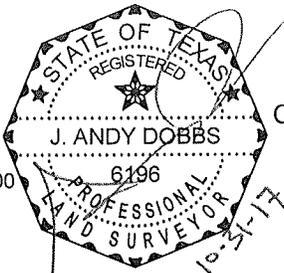

Kimley»Horn

13455 Noel Road, Two Galleria Office Tower, Suite 700, Dallas, Texas 75240 FIRM # 10115500 Tel. No. (972) 770-1300 Fax No. (972) 239-3820

Scale	Drawn by	Checked by	Date	Project No.	Sheet No.
N/A	MTC	JAD	OCT. 2017	064513900	1 OF 3

THENCE with said west right-of-way line of the Kansas City Southern Railroad, the following courses and distances:

- South 22°24'01" East, a distance of 879.63 feet to a point for corner;
- South 89°07'01" East, a distance of 27.22 feet to a point for corner;
- South 22°24'01" East, a distance of 1073.27 feet to a point for corner;
- South 16°45'10" East, a distance of 230.32 feet to a point for the north corner of Lot 1, Block 1, Denton Distribution Center, an addition to the City of Denton according to the plat recorded in Cabinet M, Page 130 of said Plat Records;

THENCE departing said west right-of-way line of the Kansas City Southern Railroad and with the north line of said Lot 1, Block 1, the following courses and distances:

- South 60°02'59" West, a distance of 244.47 feet to a point at the beginning of a tangent curve to the left having a central angle of 14°52'31", a radius of 1155.92 feet, a chord bearing and distance of South 52°38'45" West, 299.26 feet;
- In a southwesterly direction, with said curve to the left, an arc distance of 300.10 feet to a point for the northeast corner of Tract B, Better Tools Property, an addition to the City of Denton according to the plat recorded in Cabinet A, Page 118 of said Plat Records;




THENCE departing said north line of Lot 1, Block 1 and with the north line of said Better Tools Property, North 89°03'53" West, a distance of 1303.23 feet to the **POINT OF BEGINNING** and containing 71.76 acres of land.

This document was prepared under 22 TAC §663.21, does not reflect the results of an on the ground survey, and is not to be used to convey or establish interests in real property except those rights and interests implied or established by the creation or reconfiguration of the boundary of the political subdivision for which it was prepared.

EXHIBIT
71.76 ACRES
EUGENE PUCHALSKI SURVEY,
ABSTRACT NO. 996
CITY OF DENTON, DENTON COUNTY, TEXAS

<h1 style="margin: 0;">Kimley»Horn</h1>					
13455 Noel Road, Two Galleria Office Tower, Suite 700, Dallas, Texas 75240 FIRM # 10115500 Tel. No. (972) 770-1300 Fax No. (972) 239-3820					
<u>Scale</u>	<u>Drawn by</u>	<u>Checked by</u>	<u>Date</u>	<u>Project No.</u>	<u>Sheet No.</u>
N/A	MTC	JAD	OCT. 2017	064513900	2 OF 3

Exhibit B
Conceptual Plans

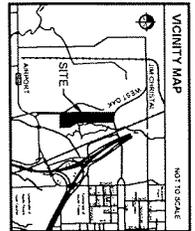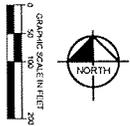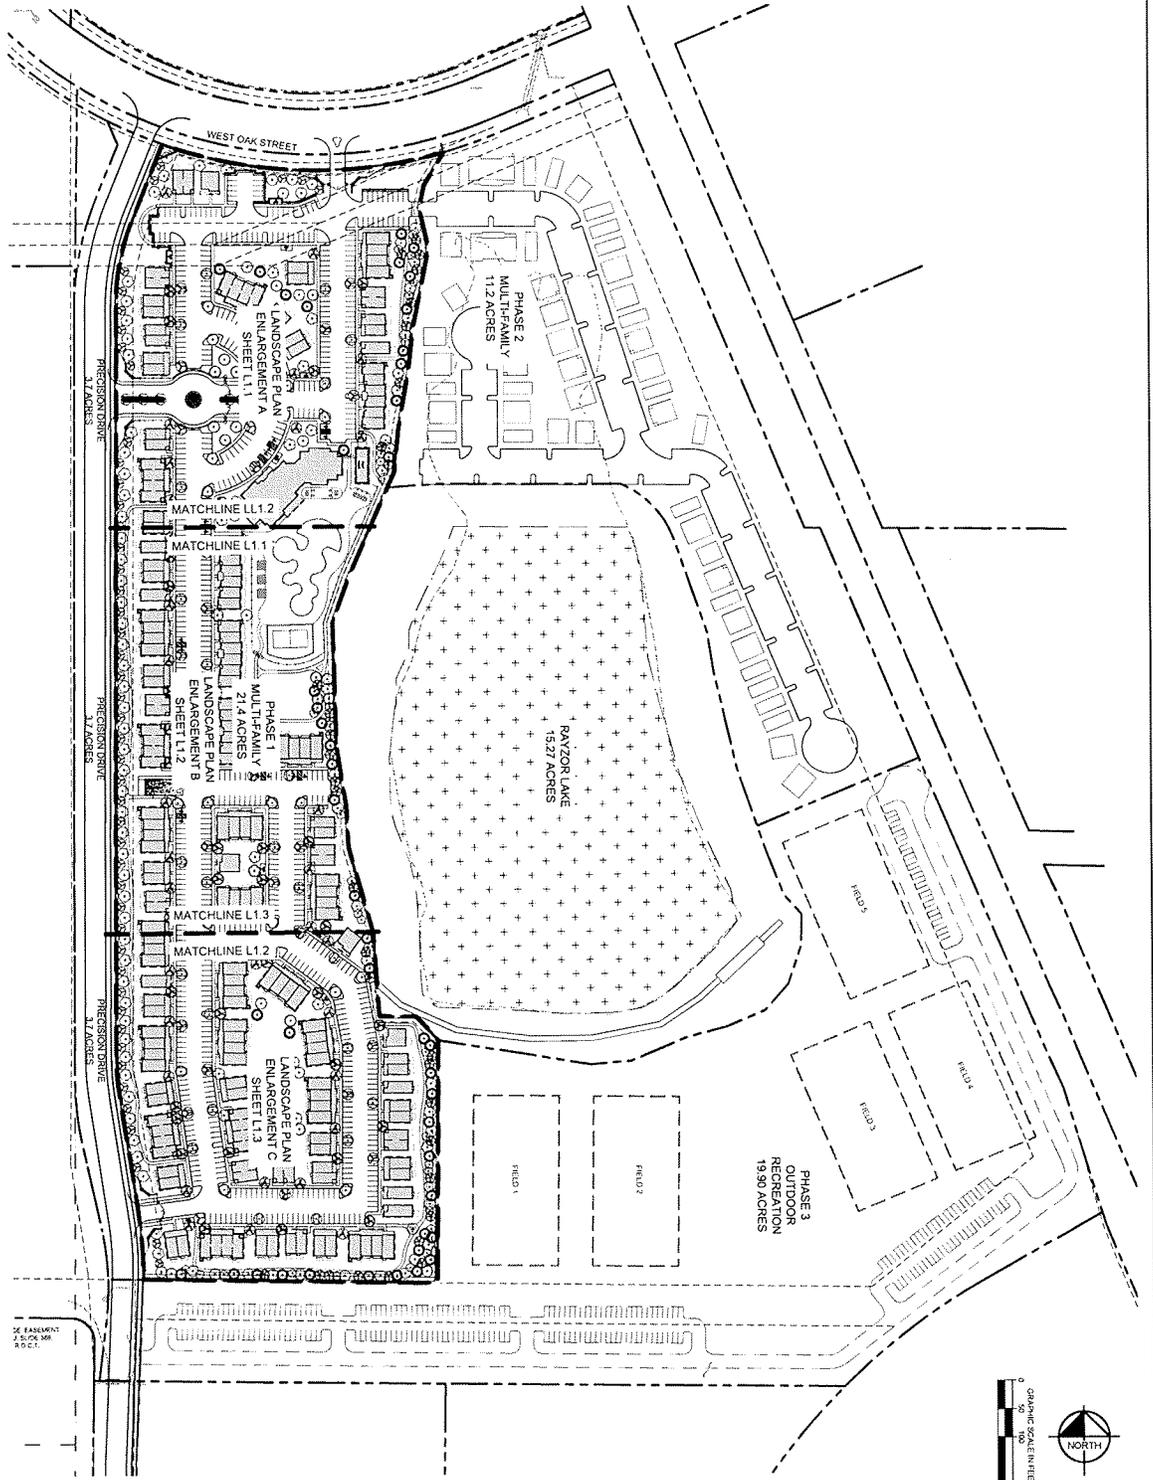

SHEET NO. L10	CONCEPTUAL OVERALL LANDSCAPE PLAN	RETREAT AT DENTON PREPARED FOR LANDMARK PROPERTIES DENTON TEXAS	KHA PROJECT 64513900 DATE 09/01/2017 SCALE AS SHOWN DESIGNED BY SEM DRAWN BY SEM CHECKED BY KHW		Kimley-Horn 12750 MERIT DRIVE, SUITE 1000 DALLAS, TX 75251 PHONE 972-701-1500 FAX 972-709-3620 WWW.KIMLEY-HORN.COM TX F-628 © 2017 KIMLEY-HORN AND ASSOCIATES, INC	NO. REVISIONS DATE	



PRECISION DRIVE
3.7 ACRES

MATCHLINE L1 2



PLANT LEGEND




TREES	CODE	SCIENTIFIC NAME	COMMON NAME
	AK	ALNUS BARKERIANA	CRUDO WALNUT
	CT	CESTRUM CANDIDISSIMUM TERNstroemii	TEXAS BIGNONIA
	KA	KELPA GYMOKA	SPRINGWATER HOLLY
	PC	PERSEA DULCISFRUTA	AMERICAN PEAR
	PC2	PERSEA KALAMOCHINENSIS	CHEESE TREE/KAHOE
	PE	PERSEA BARKERIANA	AMERICAN PEAR
	PM	PERSEA MEXICANA	MEXICAN PEAR
	QD	QUERCUS STELLATA	POST OAK
	QD2	QUERCUS SPINOSA	SHUMARD RED OAK
	QV	QUERCUS VIRGINIANA	SOUTHERN LIVE OAK
	TD	TAXODIUM DISTICHUM	BALD CYPRESS
	US	ULMUS PARVIFOLIUS SIMPERNENSIS	LACINIAE ELM
	US2	ULMUS CRINITA BURSERIANA	DOWNY BARK OLD HOLLY
	US3	ULMUS CRINITA BURSERIANA	DOWNY BARK OLD HOLLY
	US4	ULMUS CRINITA BURSERIANA	DOWNY BARK OLD HOLLY
	US5	ULMUS CRINITA BURSERIANA	DOWNY BARK OLD HOLLY
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	US100	ULMUS CRINITA BURSERIANA	DOWNY BARK OLD HOLLY

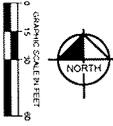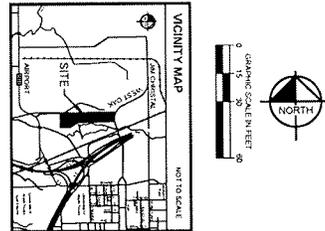

CONCEPTUAL LANDSCAPE PLAN ENLARGEMENT C	RETREAT AT DENTON PREPARED FOR LANDMARK PROPERTIES DENTON TEXAS	KHA PROJECT 64513800		Kimley-Horn 12750 MERIT DRIVE, SUITE 1000, DALLAS, TX 75251 PHONE: 972-775-1200 FAX: 972-239-5820 WWW.KIMLEY-HORN.COM TX# 624
		DATE 09/01/2017 SCALE AS SHOWN DESIGNED BY SEM DRAWN BY SEM CHECKED BY KHA		
SHEET NUMBER L1.3	REVISIONS	DATE	NO.	DATE


The Birchmore





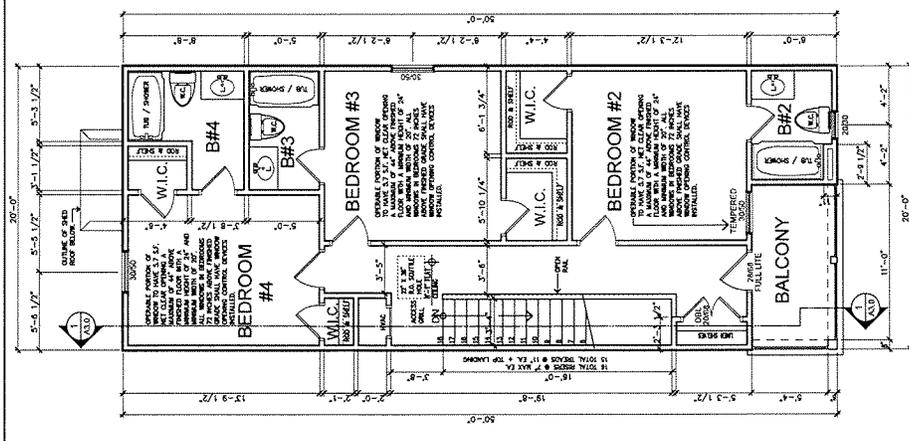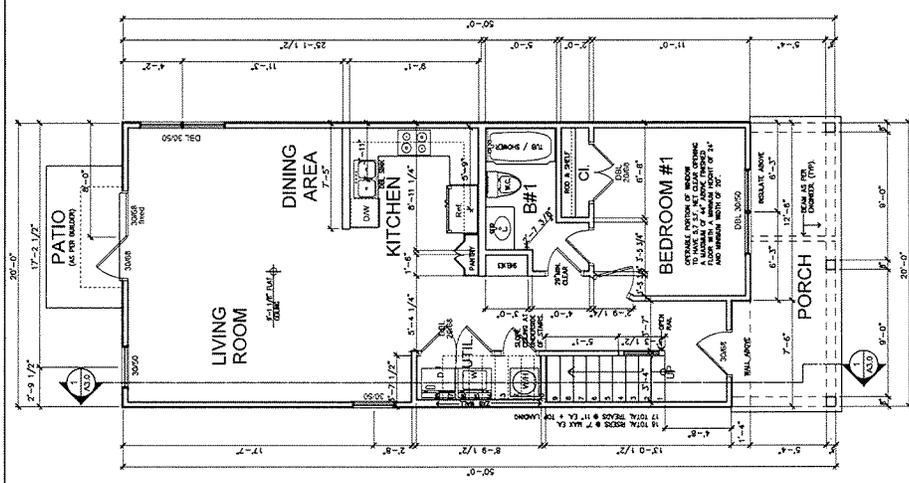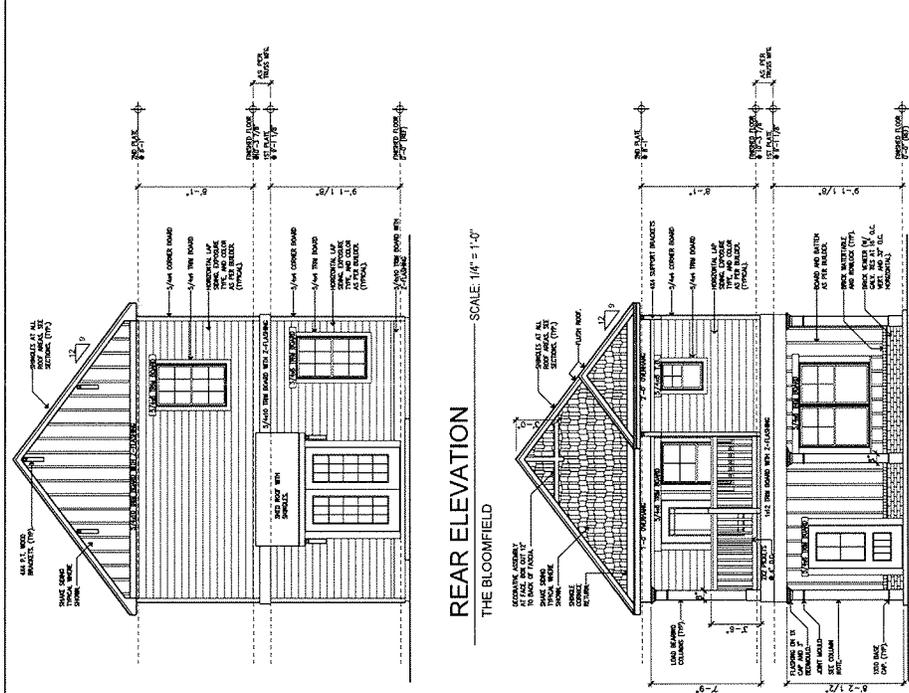

- GENERAL NOTES**
- NOTE: CONTRACTOR TO PROVIDE ADDITIONAL ENGINEERING AS REQUIRED.
 - NOTE: SEE EXTERIOR ELEVATIONS FOR DOOR AND WINDOW STYLES, INTERIOR DOORS AS NOTED, STILE AND FINISH AS PER OWNER.
 - NOTE: ALL BATHROOM DOORS SHALL BE 7'-0" X 6'-0" OR AS NOTED.
 - NOTE: ALL CLOSET DOORS SHALL BE 7'-0" X 6'-0" OR AS NOTED.
 - NOTE: ALL EXTERIOR DIMENSIONS ARE TO OUTSIDE FACE OF STUD WALL FRAMING UNLESS OTHERWISE INDICATED.
 - NOTE: WALL FRAMING UNLESS OTHERWISE INDICATED.
 - NOTE: ALL EXTERIOR FINISHES SHALL BE AS NOTED, FASTENED TO CONCRETE AND SHALL BE A MINIMUM OF 4" NODS.
 - NOTE: REAR PATIO SHALL BE AS PER BUILDER AND WITH STEPS TO GRADE. PATIO AND STEPS SHALL BE CONSTRUCTED AS PER DETAILS LISTED ON CONSTRUCTION SET.
 - NOTE: ALL CONSTRUCTION SHALL BE AS PER DETAILS LISTED ON COVER SHEET.
 - NOTE: FLOOR SURFACE ON BOTH SIDES OF THE DOOR SHALL NOT VARY MORE THAN 1/2" FOR A DISTANCE NOT LESS THAN THE WIDTH OF THE DOOR FROM THE CENTERLINE TO THE FINISH SURFACE.
 - NOTE: EACH UNIT SHALL HAVE A MINIMUM OF ONE TYPE 2A 100 LB. FIRE EXTINGUISHER LOCATED UNDER KITCHEN SINK OR OTHER NORMAL PATHS OF TRAVEL, INCLUDING EXITS FROM AREAS.
 - NOTE: ALL LOAD BEARING HEADERS SHALL BE A MINIMUM OF DOUBLE 2X10 LVL AS ENGINEERED.
 - NOTE: ALL HEADERS THAT EXCEED ALLOWABLE SPANS AS PER CODE SHALL BE LVL AS ENGINEERED.
 - NOTE: REAR PATIO SHALL BE AS PER BUILDER AND WITH STEPS TO GRADE. PATIO AND STEPS SHALL BE CONSTRUCTED AS PER DETAILS LISTED ON CONSTRUCTION SET.
- WALL NOTES**
- 2x4 WOOD STUDS AT 16" O.C. WITH 1/2" LAYER OF 1/2" G-1/2 ON EACH SIDE AT INTERIOR LOCATIONS. SEE WALL SECTIONS.


The Bloomfield

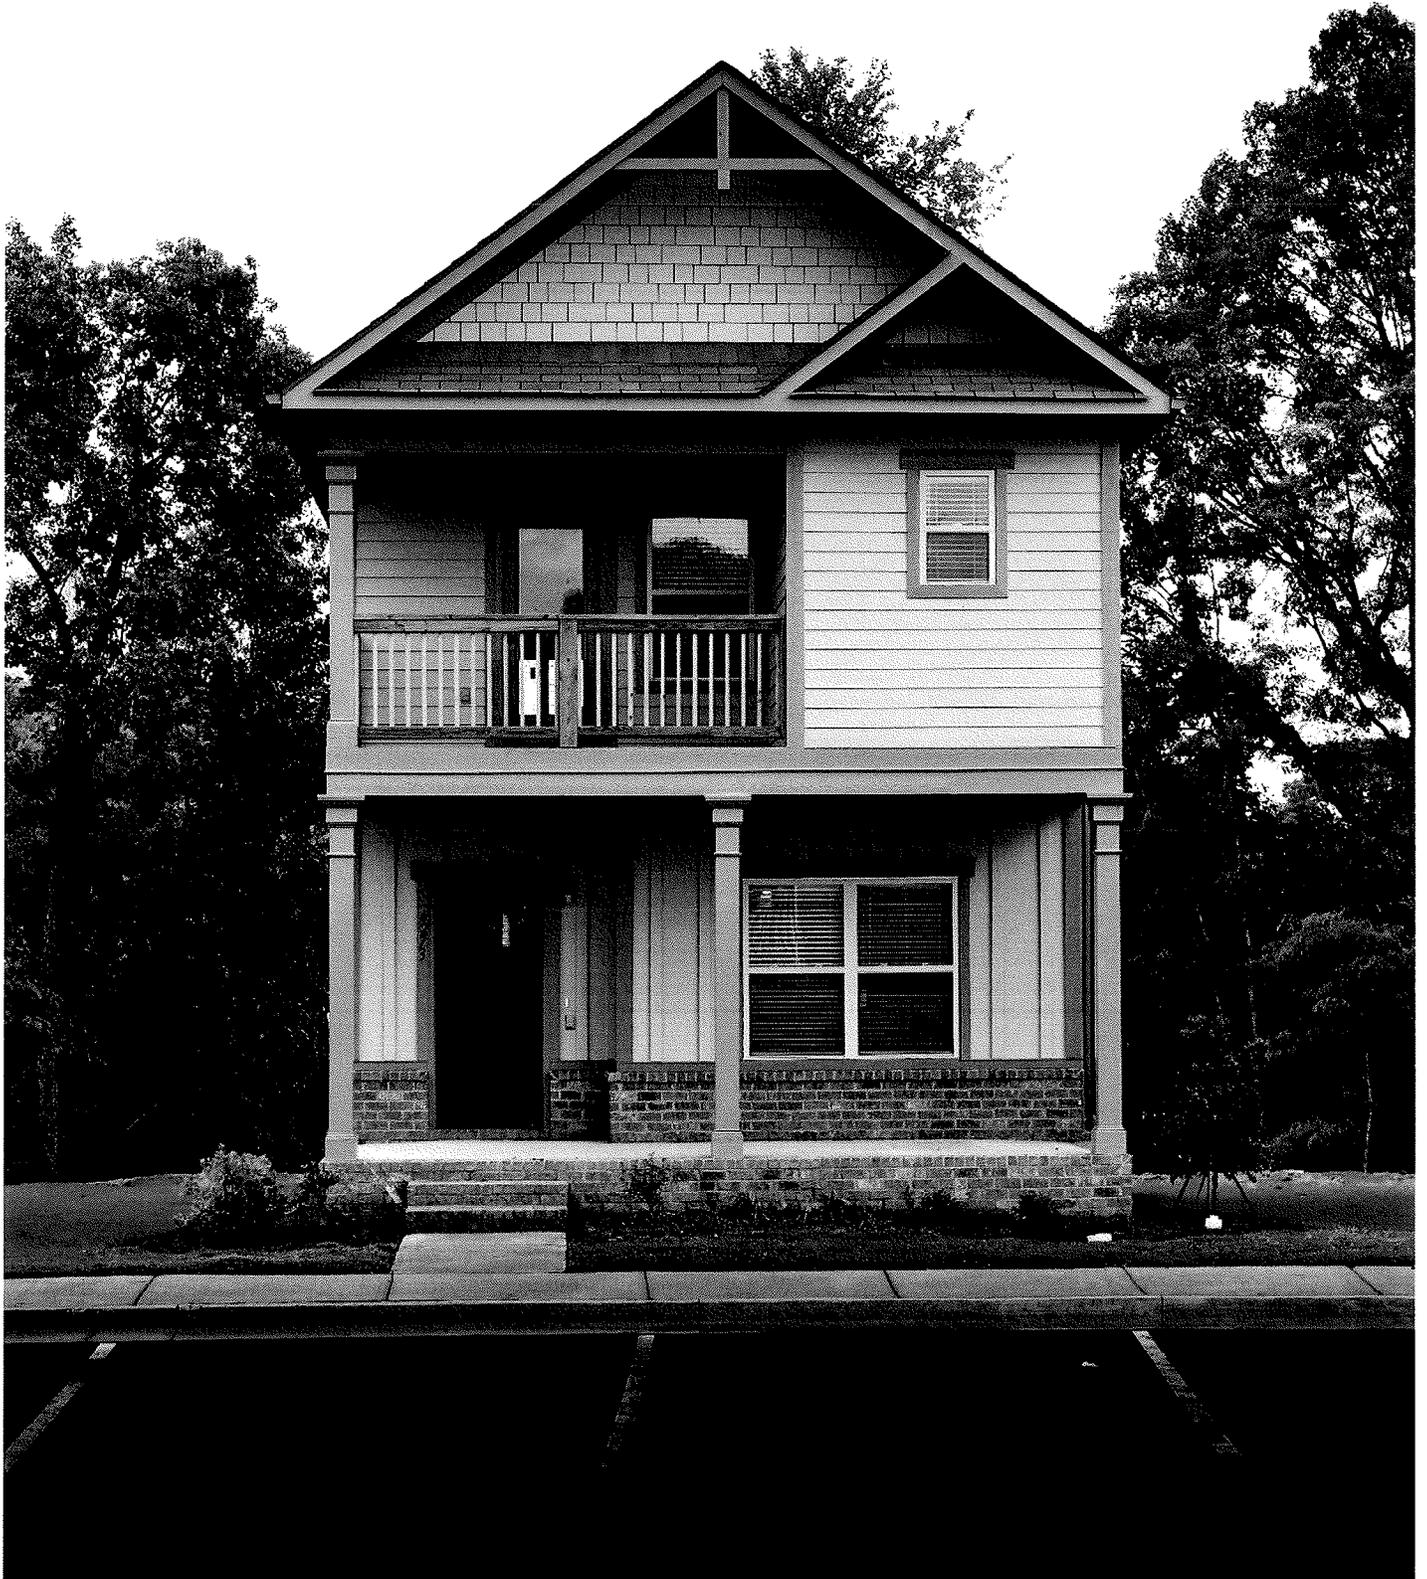

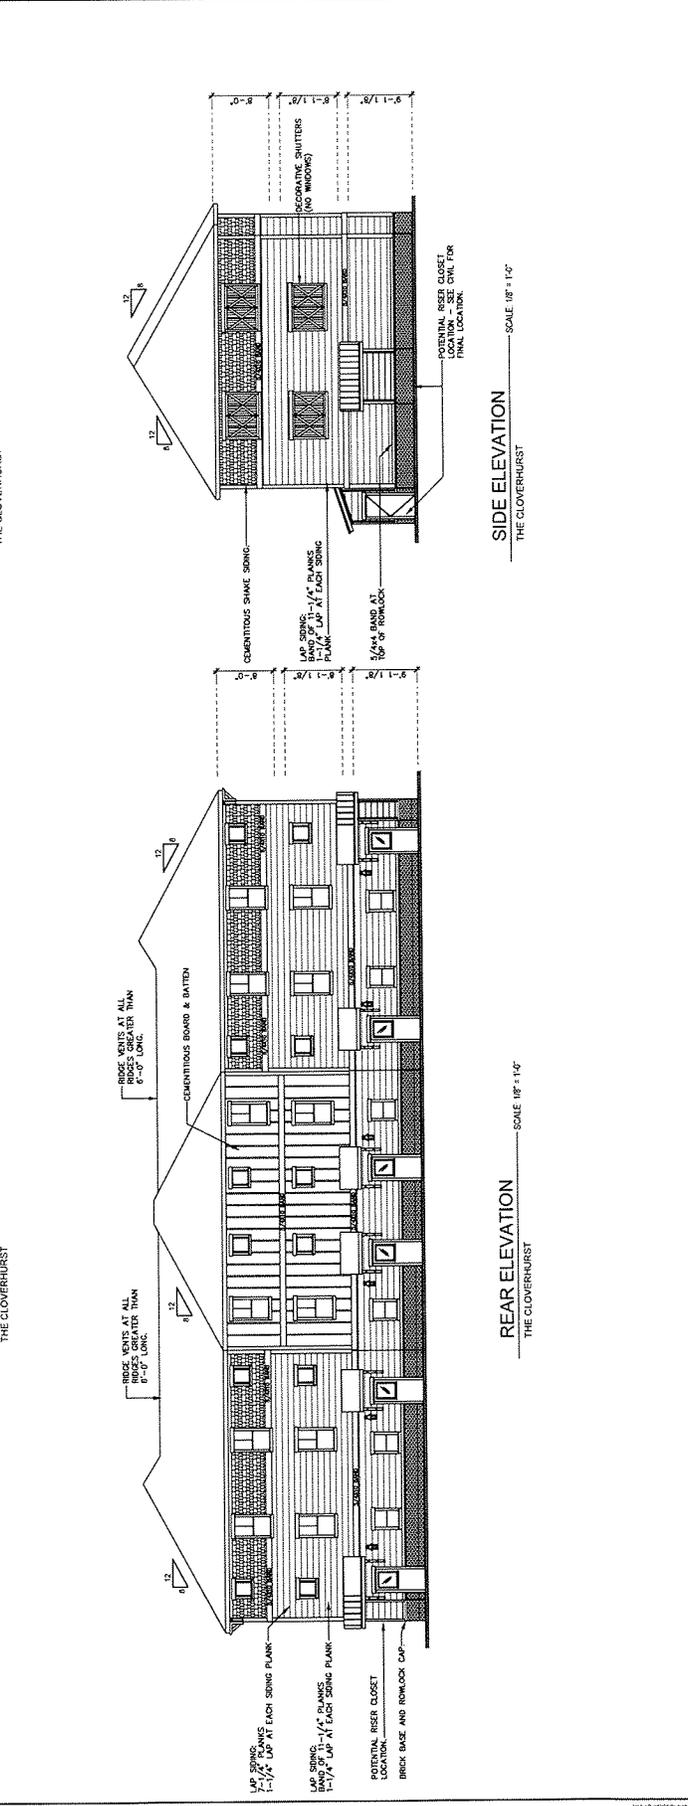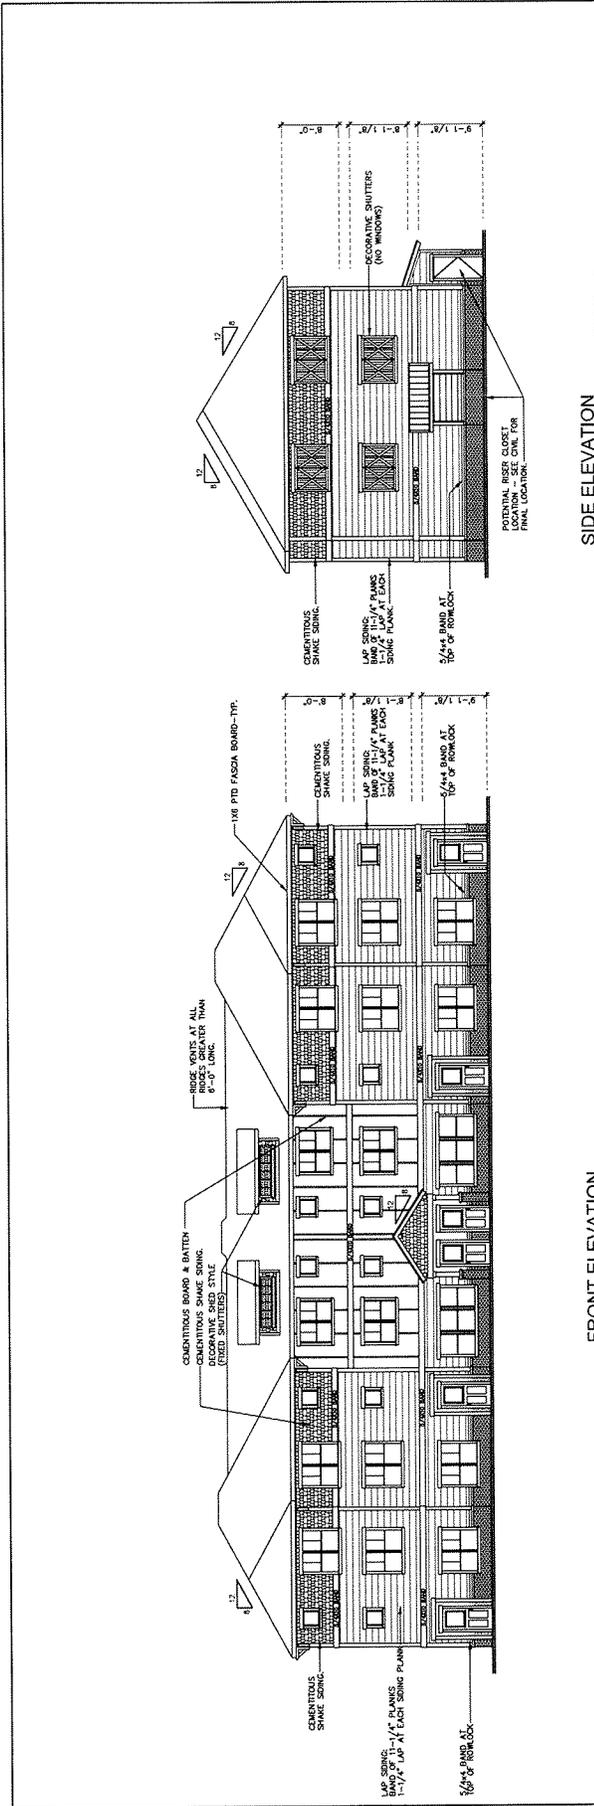


The Cloverhurst



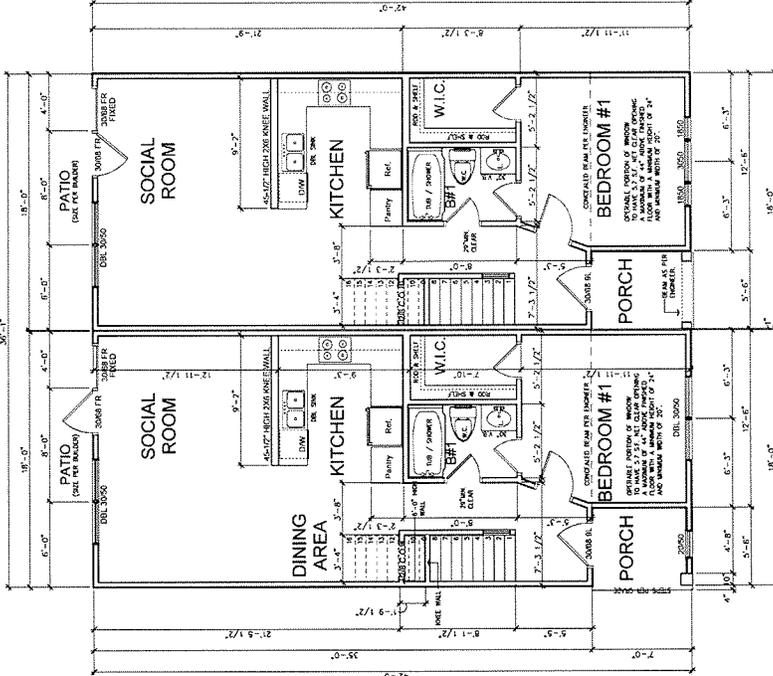

1ST FLOOR PLAN - B
THE FAIRVIEW
SCALE: 1/4" = 1'-0"

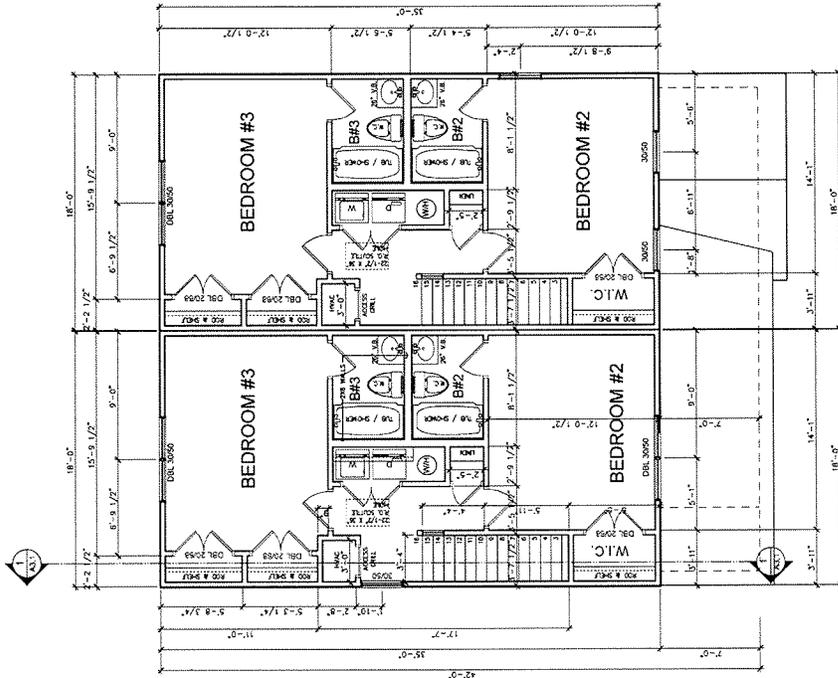

2ND FLOOR PLAN - B
THE FAIRVIEW
SCALE: 1/4" = 1'-0"


GENERAL NOTES

- NOTE: CONTRACTOR/OWNER TO PROVIDE ADDITIONAL ENGINEERING FOR PATIOS.
- NOTE: SEE INTERIOR LOCATIONS FOR DOOR AND WINDOW STYLES, INTERIOR DOORS AS NOTED, STYLE AND FINISH AS PER OWNER. ALL INTERIOR DOORS SHALL BE 2'-4" x 6" OR AS NOTED.
- NOTE: ALL CLOSET DOORS SHALL BE 2'-4" x 6" OR AS NOTED.
- NOTE: ALL INTERIOR DIMENSIONS ON DIMENSIONED FLOOR PLANS ARE TO THE FACE OF WALLS UNLESS OTHERWISE NOTED.
- NOTE: WALL FRAMING UNLESS OTHERWISE INDICATED.


- NOTE: ALL WINDOW AND WINDOW SILL HEADERS SHALL BE 2x10 AND SHALL BE A MINIMUM OF 2x10 FASTENED TO CONCRETE DECK WITH SIMPSON HARDWARE, AS PER WIND LOAD ANALYSIS.
- NOTE: REAR PATIO SHALL BE AS PER BILLBOARD AND WITH STUDS TO GRADE. ALL PATIO DOORS SHALL BE CONSTRUCTED AS PER CODES LISTED ON COVER SHEET.
- NOTE: ALL LOAD BEARING HEADERS SHALL BE A MINIMUM OF DOUBLE 2x10 ALL HEADERS THAT EXCEED ALLOWABLE SPANS AS PER CODE SHALL BE L.V. AS ENGINEERED.
- NOTE: ALL CONSTRUCTION SHALL BE AS PER CODES STATED ON THE COVER SHEET.

WALL NOTES


- 2x4 WOOD STUDS AT 16" O.C. WITH 1 LAYER OF 1/2" G.W.B. ON EACH BRICK AT INTERIOR LOCATIONS. SEE WALL SECTIONS.
- THE CONTRACTOR SHALL CONSTRUCT SHEAR WALLS AS REQUIRED BY WIND LOAD ANALYSIS RESULTS.

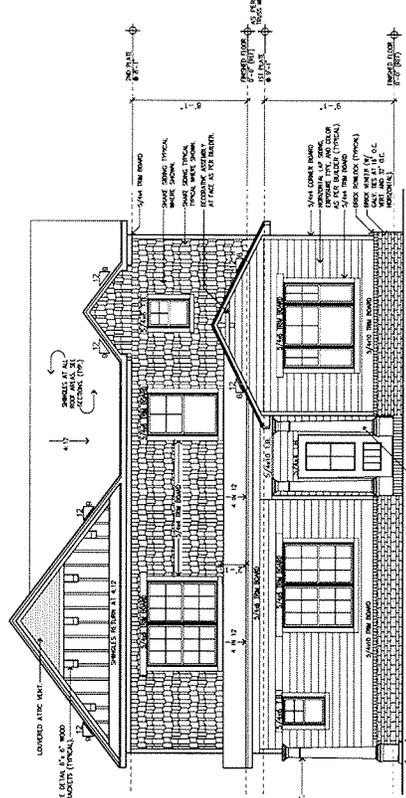


FRONT ELEVATION - B
THE FAIRVIEW
SCALE: 1/4" = 1'-0"

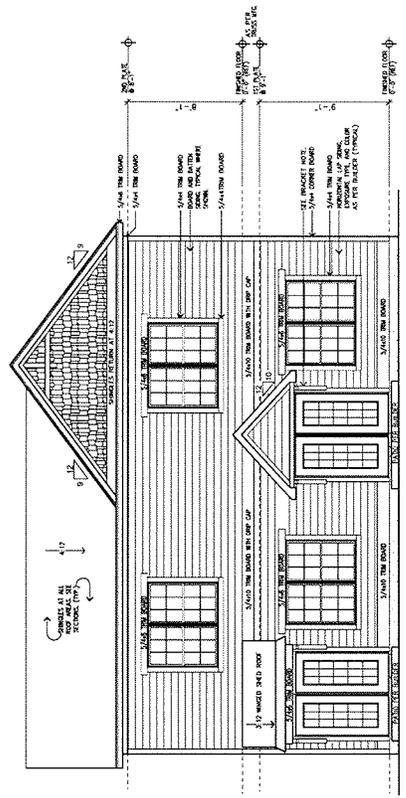

REAR ELEVATION - B
THE FAIRVIEW
SCALE: 1/4" = 1'-0"

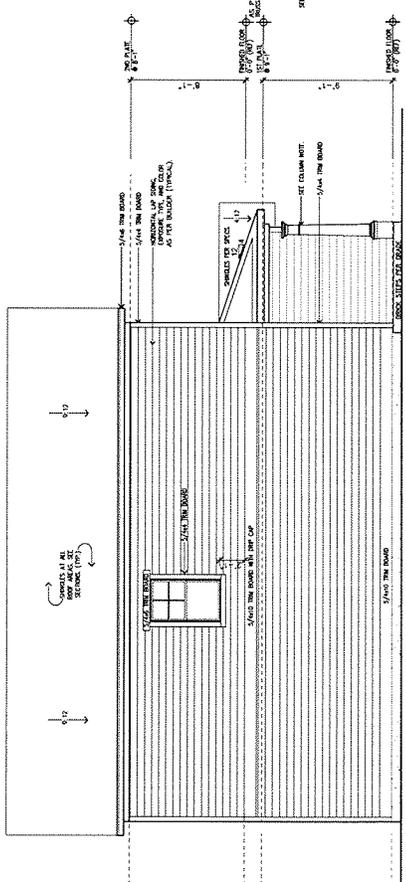

LEFT SIDE ELEVATION - B
THE FAIRVIEW
SCALE: 1/4" = 1'-0"

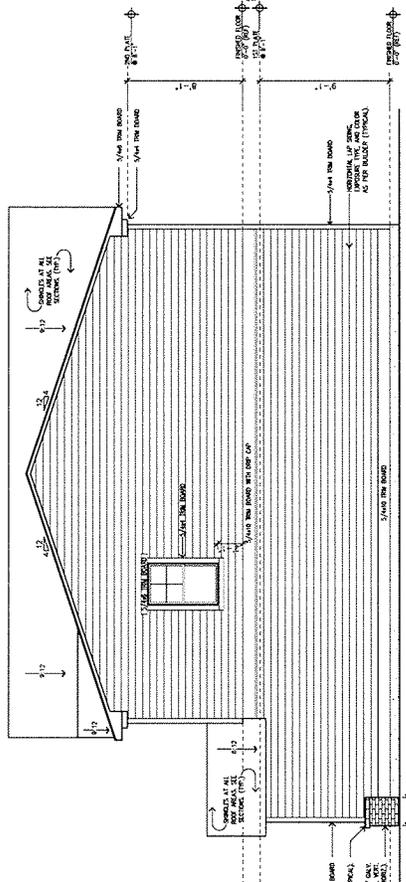


RIGHT SIDE ELEVATION - B
THE FAIRVIEW
SCALE: 1/4" = 1'-0"


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The Fairview



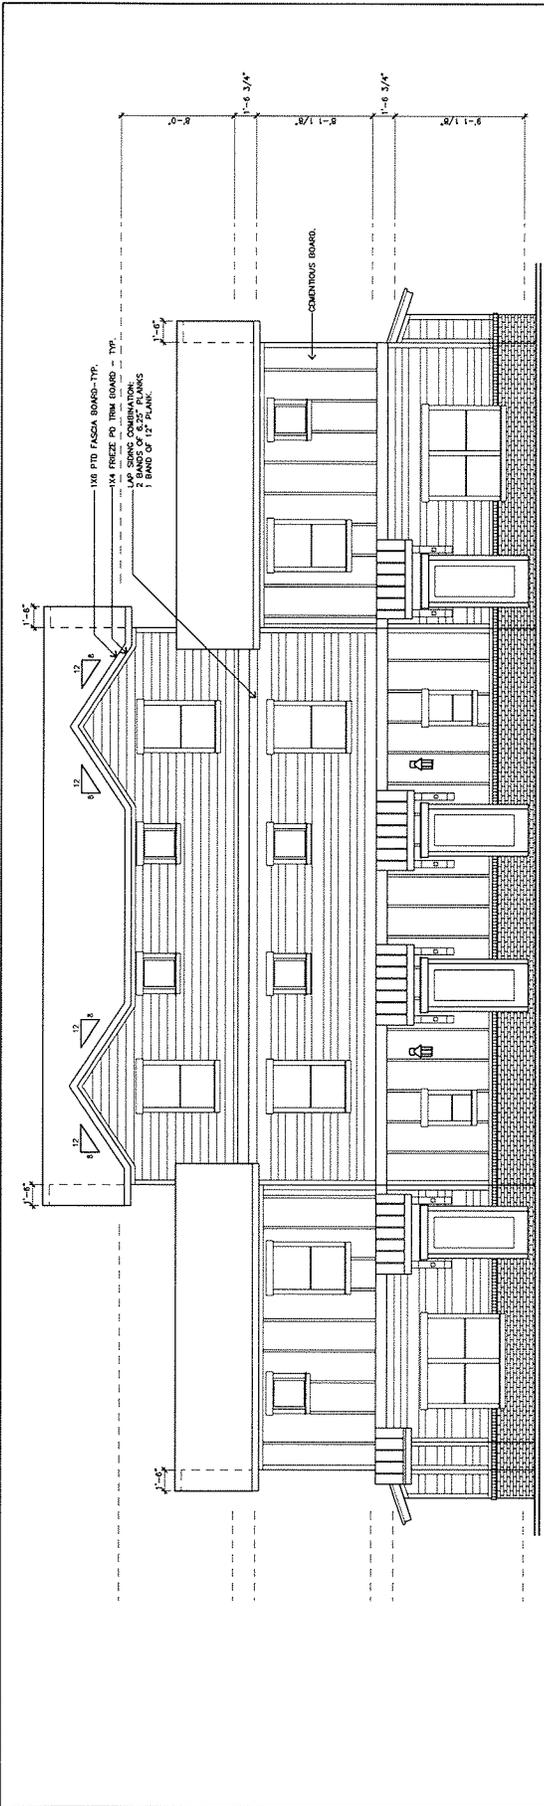

REAR ELEVATION - A
THE LUMPKIN
SCALE: 1/4" = 1'-0"

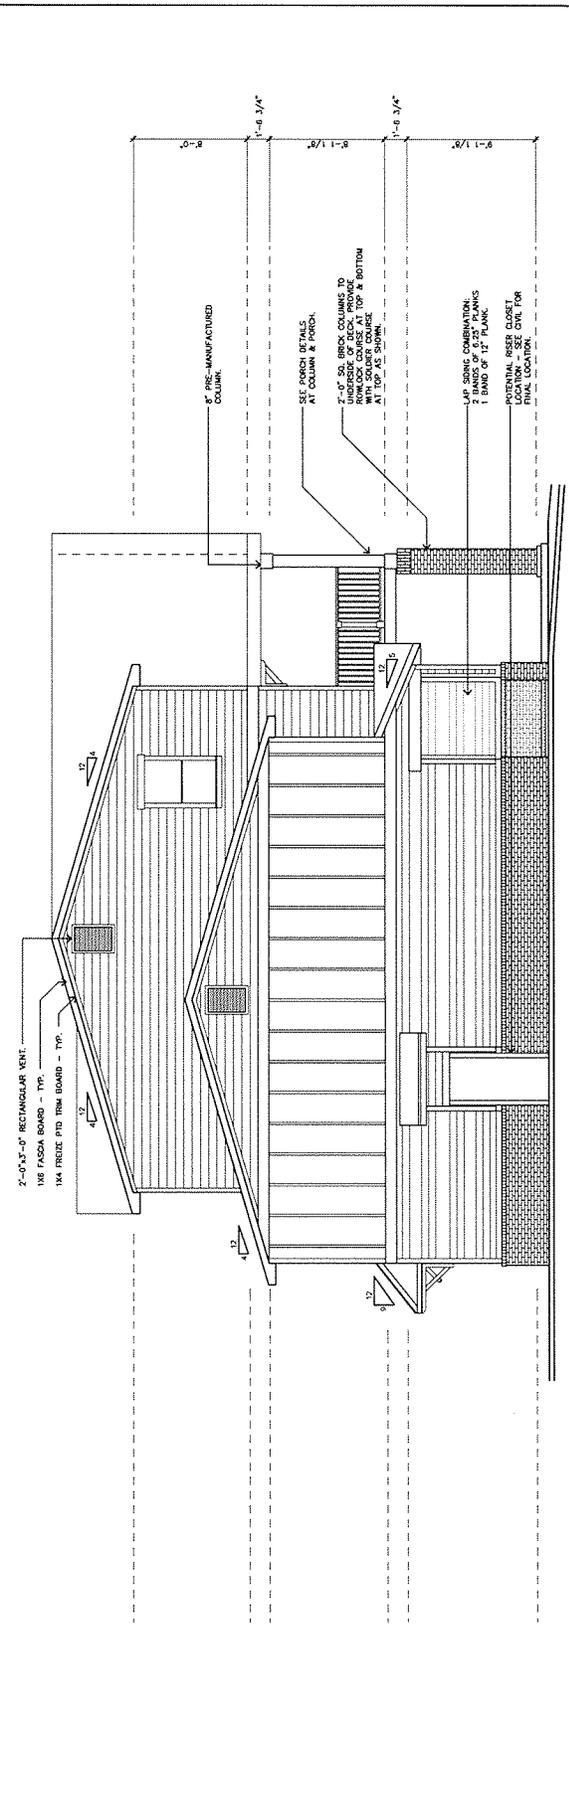

SIDE ELEVATION - A
THE LUMPKIN
SCALE: 1/4" = 1'-0"

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The Lumpkin



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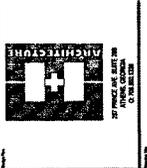
THE RETREAT AT STARKVILLE, MS

UNIT 16 THE MILLEDGE:
 (2) 4-BED UNITS (2) 3-BED UNITS

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No.	Date	Revised
1	5.10.2018	2018-11
2	5.10.2018	2018-11


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ELEVATION VARIATIONS


5.10.2018
 2018-11

MILLEDGE
A-2



ELEVATION VARIATION A

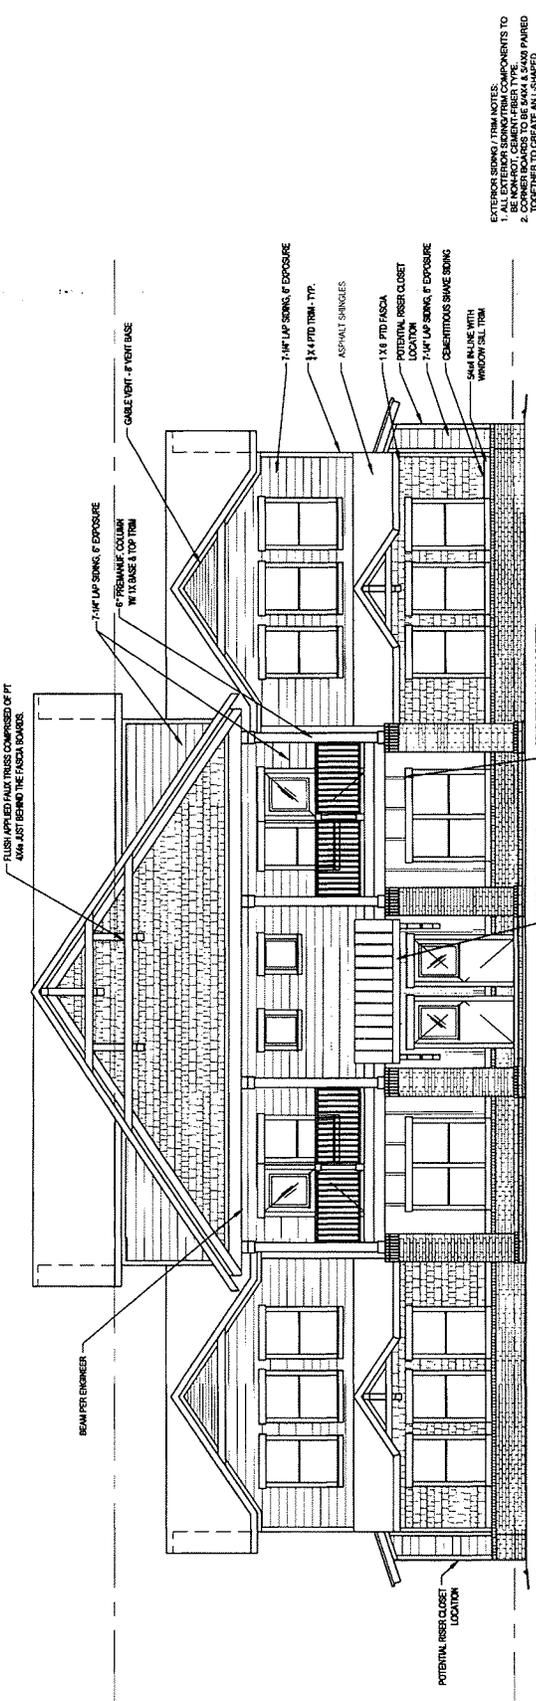1 FRONT ELEVATION
 1/4" = 1'-0"

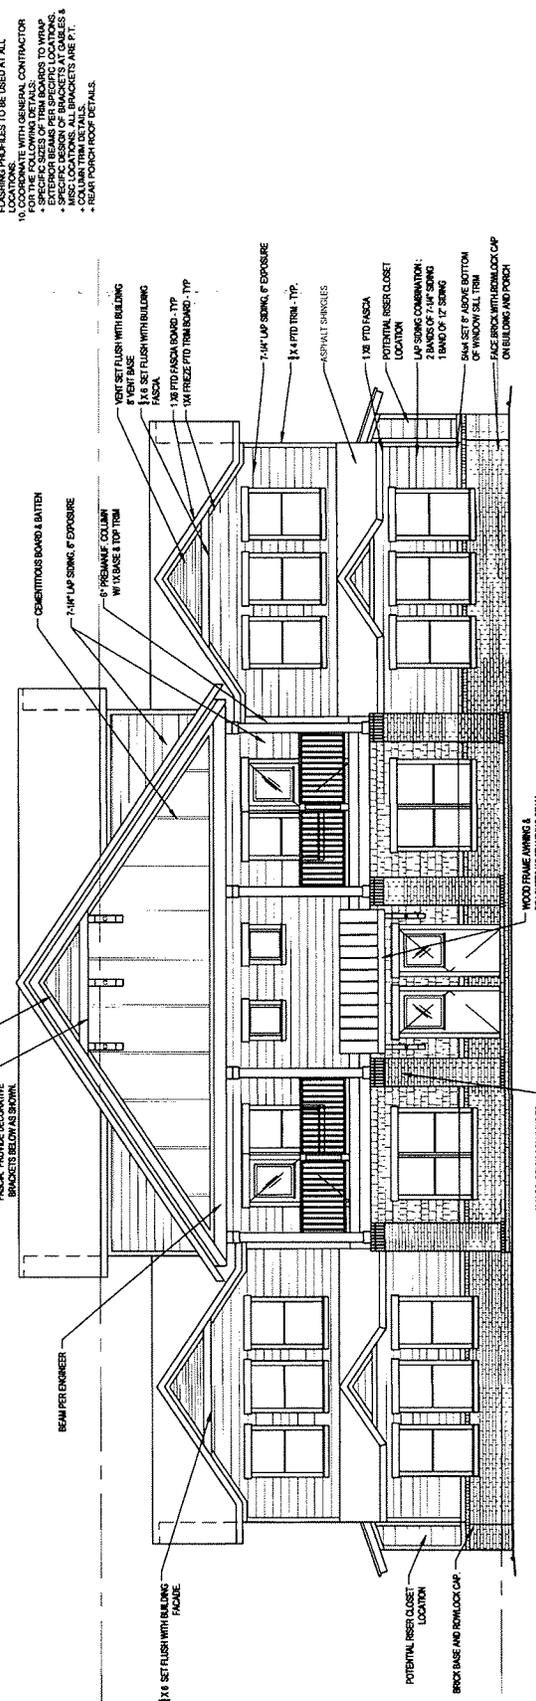

ELEVATION VARIATION B

2 FRONT ELEVATION
 1/4" = 1'-0"

1. COORDINATE WITH GENERAL CONTRACTOR FOR ALL EXTERIOR CLIMATE CONTROL COMPONENTS TO BE NON-ROT, CEMENT-FIBER TYPE, UNPAIRED TOGETHER TO CREATE AN L-SHAPED CORNER, WITH SAMS PLACED ON FRONT & REAR
2. WINDOW & DOOR TRIM TO BE SANK SIDES & SUNK TO 1/2\"/>

3. WINDOW & DOOR TRIM TO BE SANK SIDES & SUNK TO 1/2\"/>
- 4. SUNK TO 1/2\"/>
- 5. SUNK TO 1/2\"/>
- 6. SUNK TO 1/2\"/>
- 7. WITH 1/2\"/>
- 8. WITH 1/2\"/>
- 9. COORDINATE WITH GENERAL CONTRACTOR FOR ALL EXTERIOR CLIMATE CONTROL COMPONENTS TO BE NON-ROT, CEMENT-FIBER TYPE, UNPAIRED TOGETHER TO CREATE AN L-SHAPED CORNER, WITH SAMS PLACED ON FRONT & REAR
- 10. COORDINATE WITH GENERAL CONTRACTOR FOR ALL EXTERIOR CLIMATE CONTROL COMPONENTS TO BE NON-ROT, CEMENT-FIBER TYPE, UNPAIRED TOGETHER TO CREATE AN L-SHAPED CORNER, WITH SAMS PLACED ON FRONT & REAR

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 THE POWER SOURCE, PLLC
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**THE RETREAT AT
 STARKVILLE, MS**

UNIT 16 THE MILLEDGE
 (2) 4-BED UNITS (2) 3-BED UNITS

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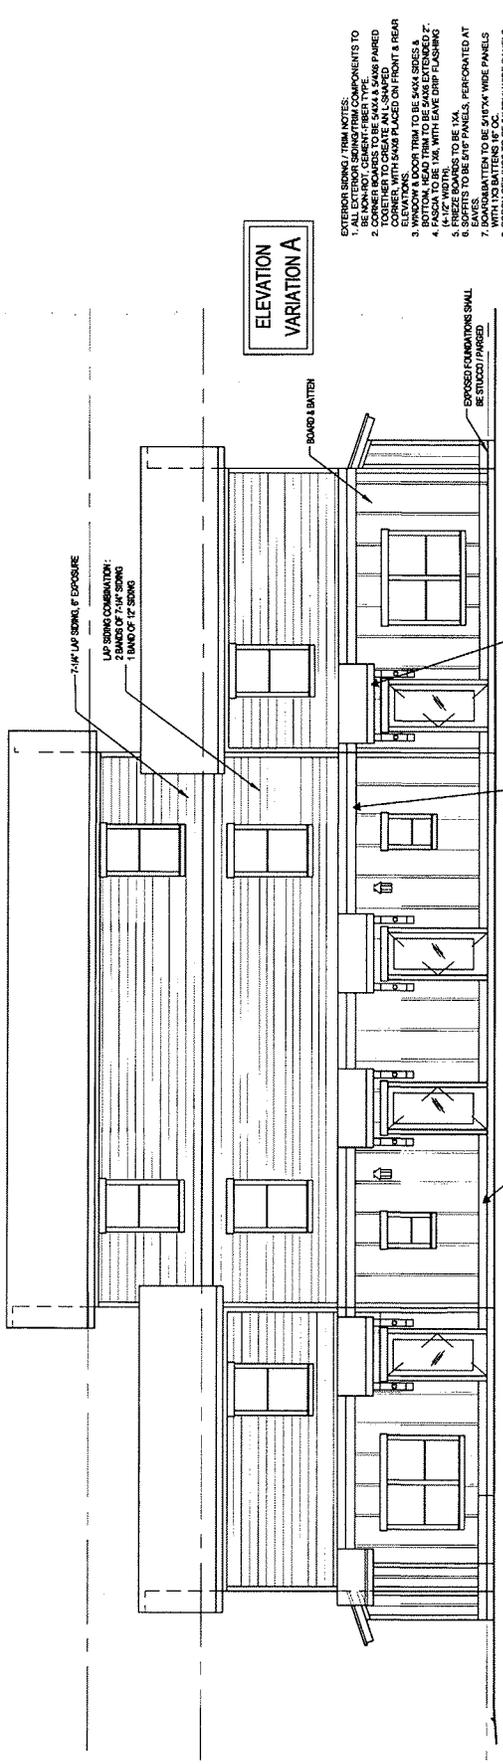
NO.	DATE	DESCRIPTION
1	5.10.2016	ISSUED FOR PERMITTING
2	2/16/17	REVISED PER COMMENTS
3	5.10.2016	ISSUED FOR PERMITTING




**SIDE & REAR
 ELEVATION
 VARIATION A**

5.10.2016
 2/16/17
 5.10.2016

MILLEDGE
A-2.1



1 REAR ELEVATION
 1/4" = 1'-0"

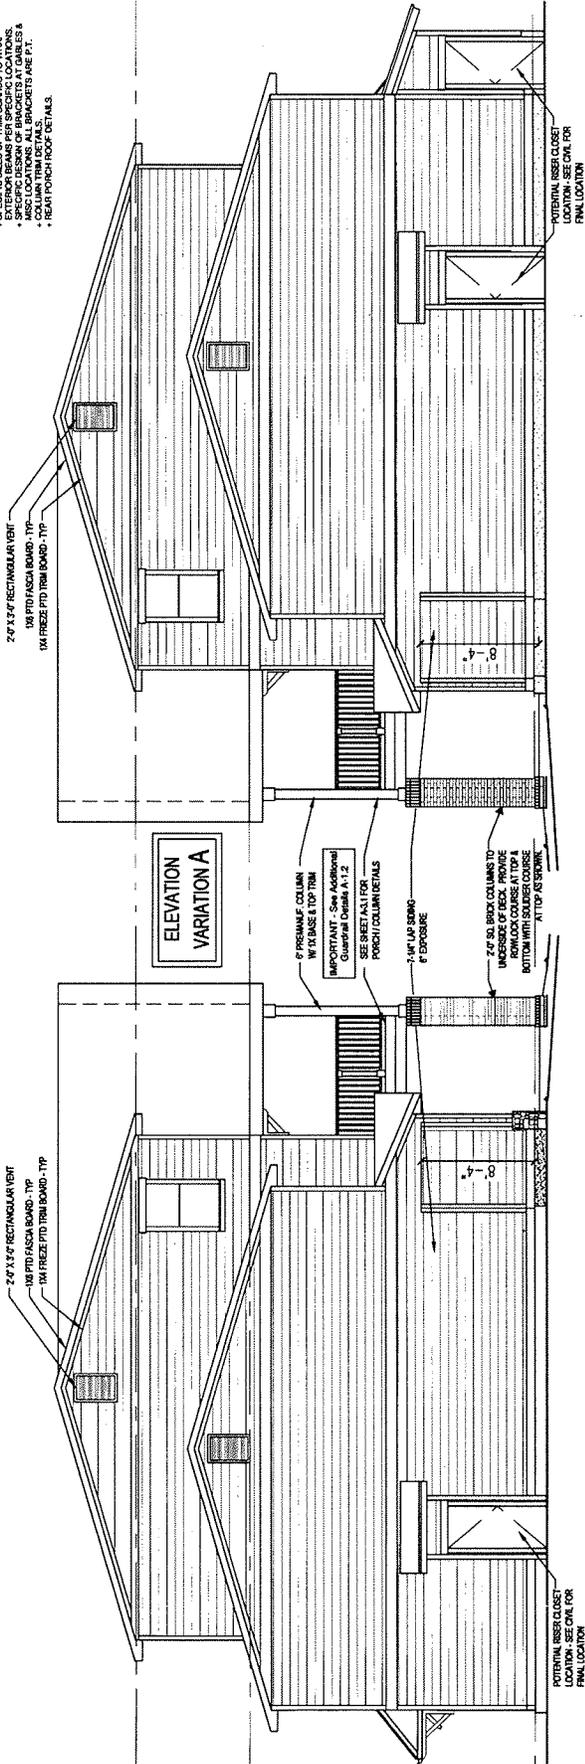

2 SIDE ELEVATION
 1/4" = 1'-0"

3 SIDE ELEVATION
 1/4" = 1'-0"


- EXTERIOR SKINS/TRIM NOTES:**
1. ALL EXTERIOR SKINS/TRIM COMPONENTS TO BE INSTALLED TO MATCH THE ADJACENT UNIT.
 2. CORNER COASERS TO BE 3/4" X 1/4" X 3/4" PARIED TOGETHER TO CREATE AN L-SHAPED ELEVATION.
 3. WINDOW & DOOR TRIM TO BE 5/8" X 3/4" SIDES & 1/2" X 3/4" TOPS & BOTTOMS.
 4. FASCIA TO BE 1/2" X 3/4" WITH LEAVE DRIP FLASHING.
 5. PRESSURE TREATED LUMBER TO BE 1/2" X 4".
 6. SPOFFETS TO BE 5/8" PANELS, PERFORATED AT 1/4" INTERVALS.
 7. DOWNSPUTTERS TO BE 5/8" X 1/4" WIDE PANELS WITH 1/2" BATTENS AT 1/4" INTERVALS.
 8. WITH 1/2" BATTENS AT JOINTS & PERMETER.
 9. ALL EXTERIOR SKINS/TRIM TO BE INSTALLED TO MATCH THE ADJACENT UNIT.
 10. ALL EXTERIOR SKINS/TRIM TO BE INSTALLED TO MATCH THE ADJACENT UNIT.


- SPECIFIC SIZES OF TRIM BOARDS TO MATCH SPECIFIC SIZES OF BRACKETS AT GABLES & CORNERS.
- ALL EXTERIOR SKINS/TRIM TO BE INSTALLED TO MATCH THE ADJACENT UNIT.
- REAR PORCH ROOF DETAILS.

POTENTIAL RISER CLOSET LOCATION USE CALL FOR PANEL LOCATION


POTENTIAL RISER CLOSET LOCATION USE CALL FOR PANEL LOCATION

The Milledge

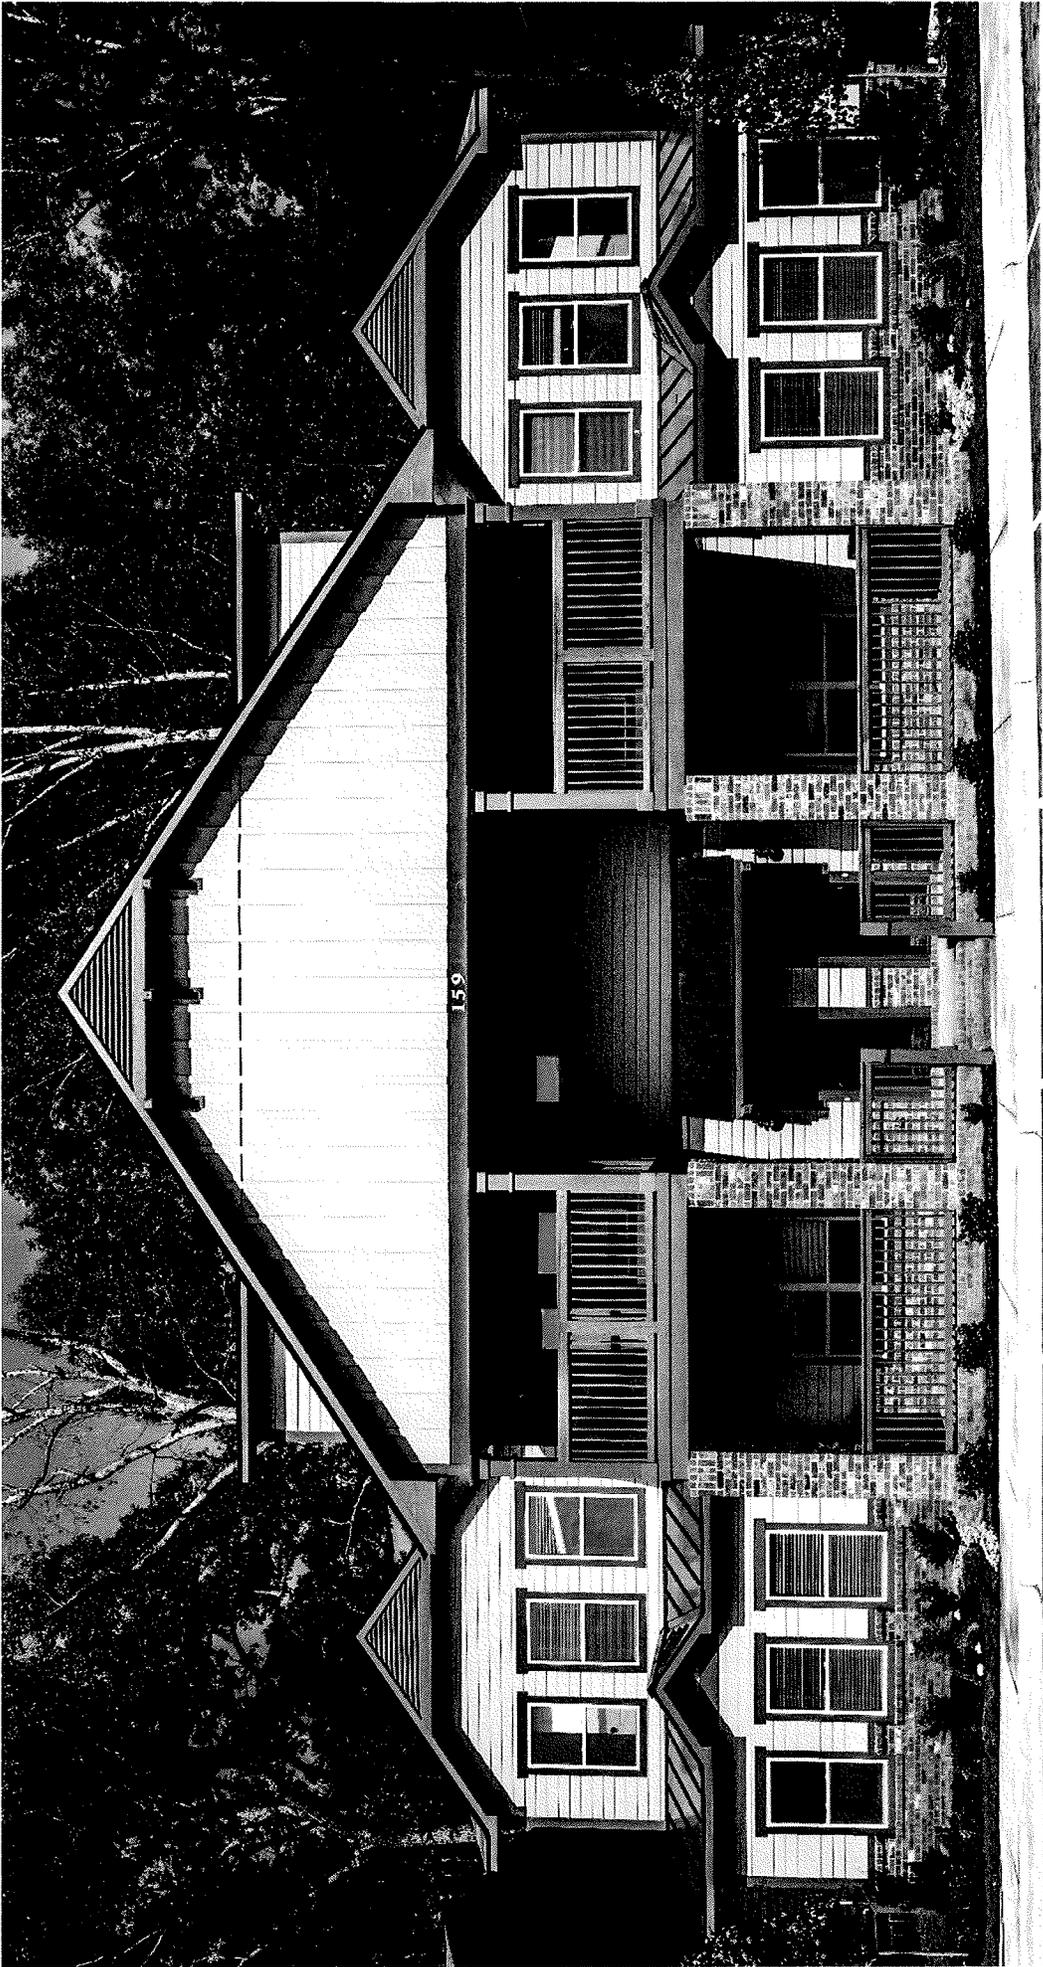


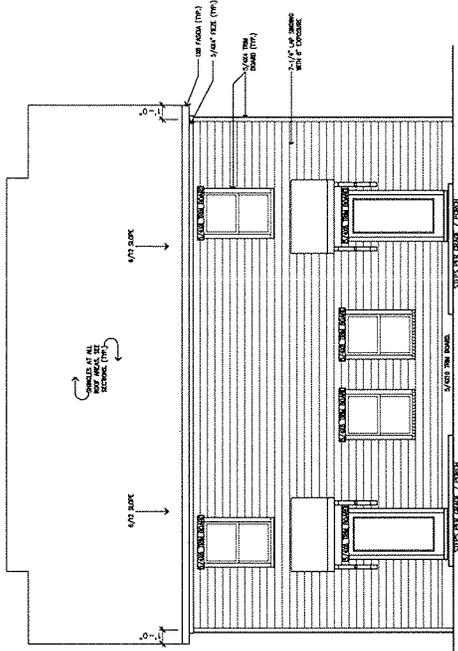


REAR ELEVATION - A
THE OAKVIEW
SCALE: 1/4" = 1'-0"

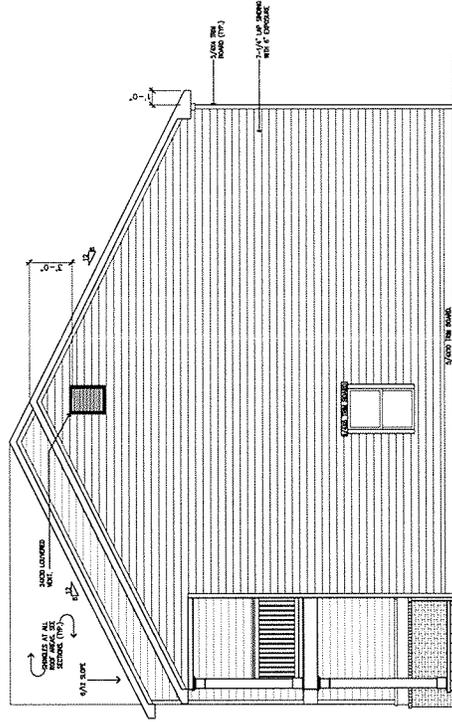

LEFT ELEVATION - A
THE OAKVIEW
SCALE: 1/4" = 1'-0"

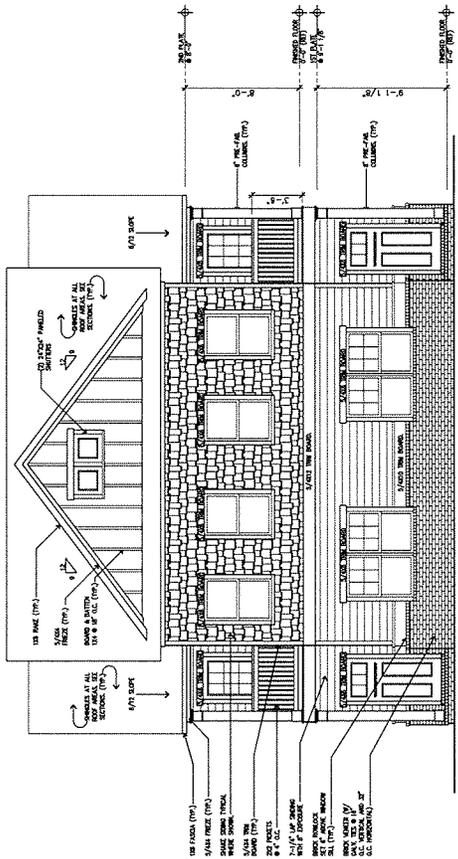

FRONT ELEVATION - A
THE OAKVIEW
SCALE: 1/4" = 1'-0"

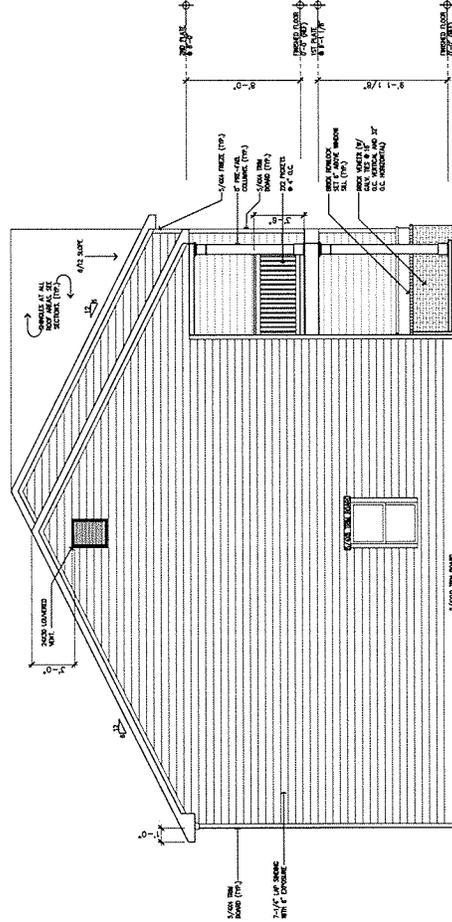


RIGHT ELEVATION - A
THE OAKVIEW
SCALE: 1/4" = 1'-0"

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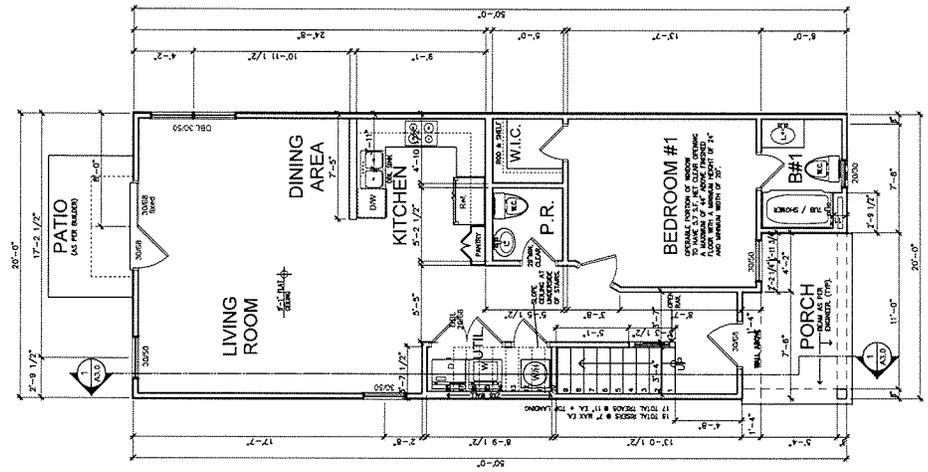
The Oakview



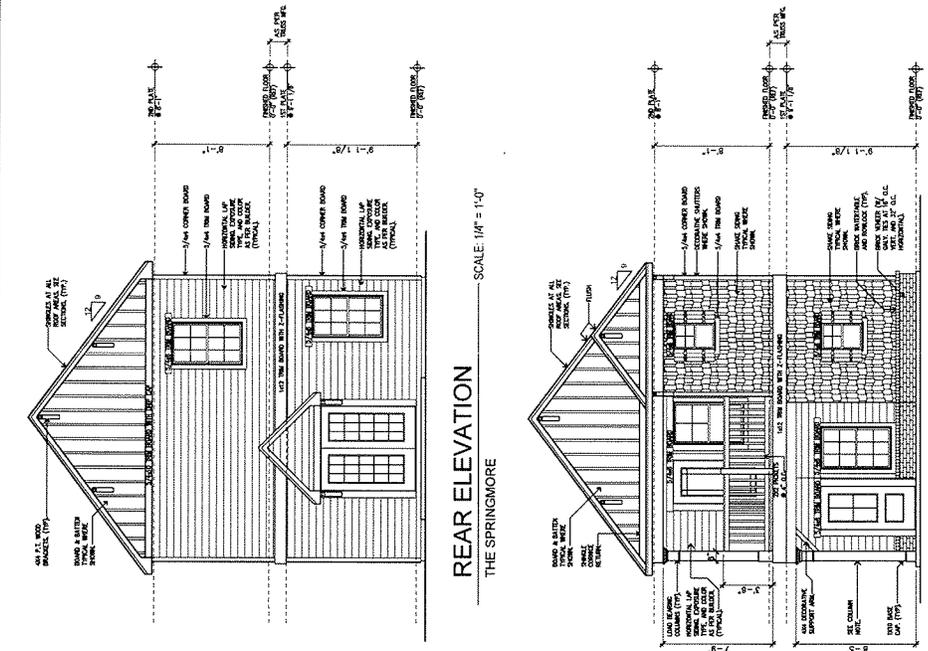


REAR ELEVATION
 THE SPRINGMORE
 SCALE: 1/4" = 1'-0"

FRONT ELEVATION
 THE SPRINGMORE
 SCALE: 1/4" = 1'-0"



1ST FLOOR PLAN
 THE SPRINGMORE
 SCALE: 1/4" = 1'-0"

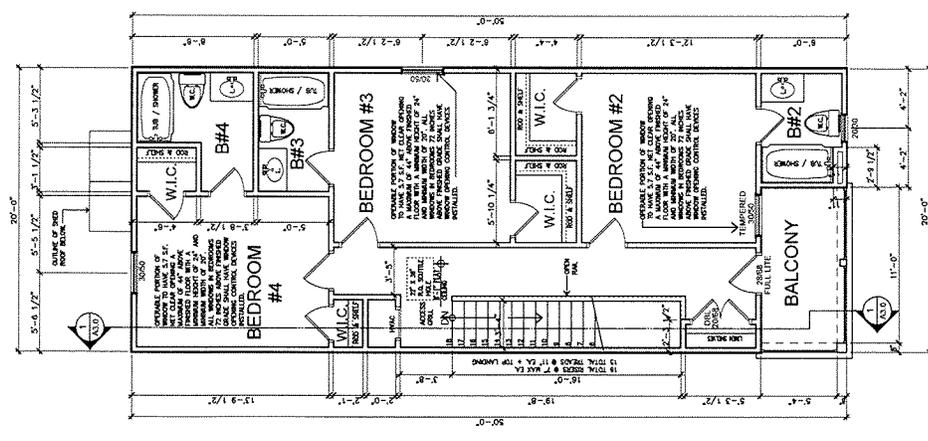


2ND FLOOR PLAN
 THE SPRINGMORE
 SCALE: 1/4" = 1'-0"


- GENERAL NOTES**
- NOTE: CONTRACTOR OWNER TO PROVIDE ADDITIONAL ENGINEERING FOR ALL EXTERIOR WALLS AND ROOFING.
 - NOTE: SEE EXTERIOR ELEVATIONS FOR DOOR AND WINDOW STYLES, INTERIOR DOORS AS NOTED, STYLE AND FINISH AS PER OWNER.
 - NOTE: ALL INTERIOR DOORS SHALL BE 2'-0" X 6'-0" OR AS NOTED.
 - NOTE: ALL CLOSET DOORS SHALL BE 2'-4" X 6'-0" OR AS NOTED.
 - NOTE: ALL INTERIOR DIMENSIONS ON DIMENSIONED FLOOR PLANS ARE TO THE FACE OF STUDS UNLESS OTHERWISE INDICATED.
 - NOTE: WALL FINISHES UNLESS OTHERWISE INDICATED.
 - NOTE: ALL EXTERIOR DIMENSIONS ARE TO OUTSIDE FACE OF STUD UNLESS OTHERWISE INDICATED.
 - NOTE: WALL FINISHES UNLESS OTHERWISE INDICATED.
 - NOTE: 2x4 WOOD STUDS AT 16" O.C. WITH 1 LAYER OF 1/2" GYPSUM BOARD ON EACH SIDE AT INTERIOR LOCATIONS. SEE WALL SECTIONS.
 - NOTE: ALL COLUMNS AND BRACKETS WILL BE DETERMINED ON SITE BECK WITH SIMPSON HARDWARE AS PER WIND LOAD ANALYSIS.
 - NOTE: REAR PATIO SHALL BE AS PER BUILDER AND WITH STEPS TO GRADE. ON COVERHEET. SHALL BE CONSTRUCTED AS PER CODES LISTED ON COVERHEET.
 - NOTE: ALL LOAD BEARING HEADERS SHALL BE A MINIMUM OF DOUBLE 2x10 Lx4 AS ENGINEERED. ALL HEADERS THAT EXCEED ALLOWABLE SPAN AS PER CODE SHALL BE Lx4 AS ENGINEERED.
 - NOTE: THE COVER SHEET SHALL BE AS PER CODES STATED ON STREET OR OTHER ELEVATION AND CONTRAST WITH BACKGROUND.
 - NOTE: FLOOR SURFACE ON BOTH SIDES OF THE DOOR SHALL NOT VARY MORE THAN 1/2" OR A DISTANCE NOT LESS THAN THE WIDTH OF THE WEIR LEAF. SEE FOUNDATION PLAN FOR DETAILS. ALL FINISHES SHALL BE AS NOTED UNLESS OTHERWISE INDICATED. LOCATED UNDER KITCHEN SINK OR OTHER NORMAL PARTS OF TRAVEL INCLUDING EXITS FROM AREAS.

The Springmore




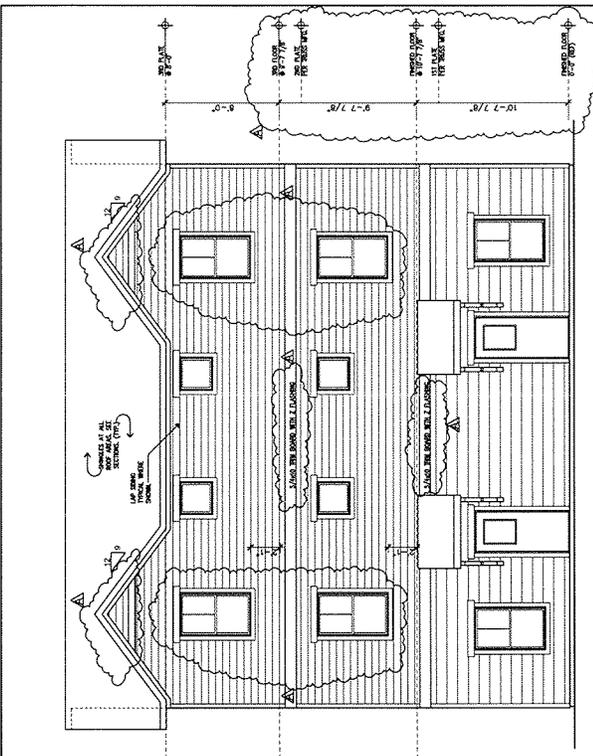

REAR ELEVATION
THE STAFFORD
SCALE: 1/4" = 1'-0"

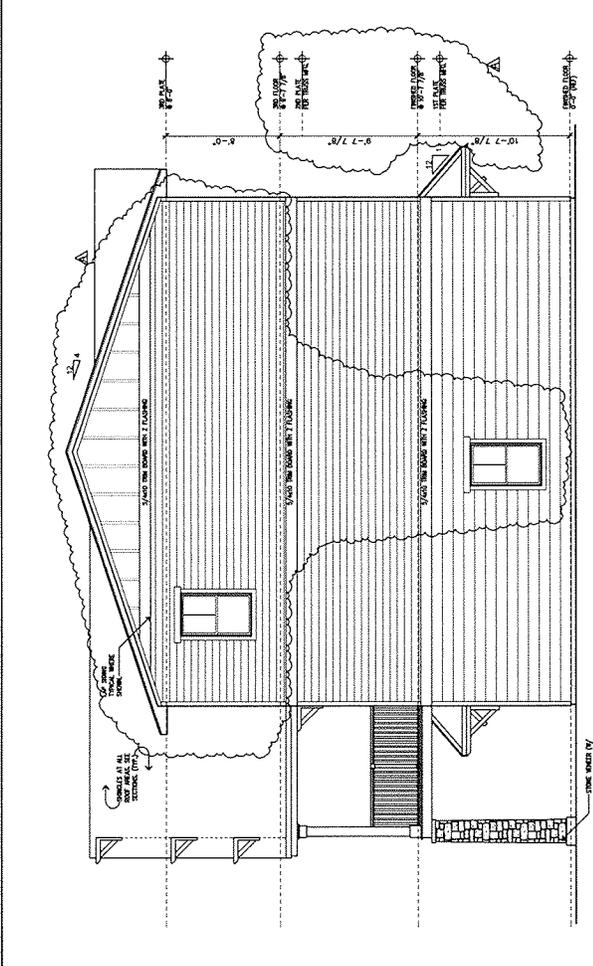

RIGHT SIDE ELEVATION
THE STAFFORD
SCALE: 1/4" = 1'-0"

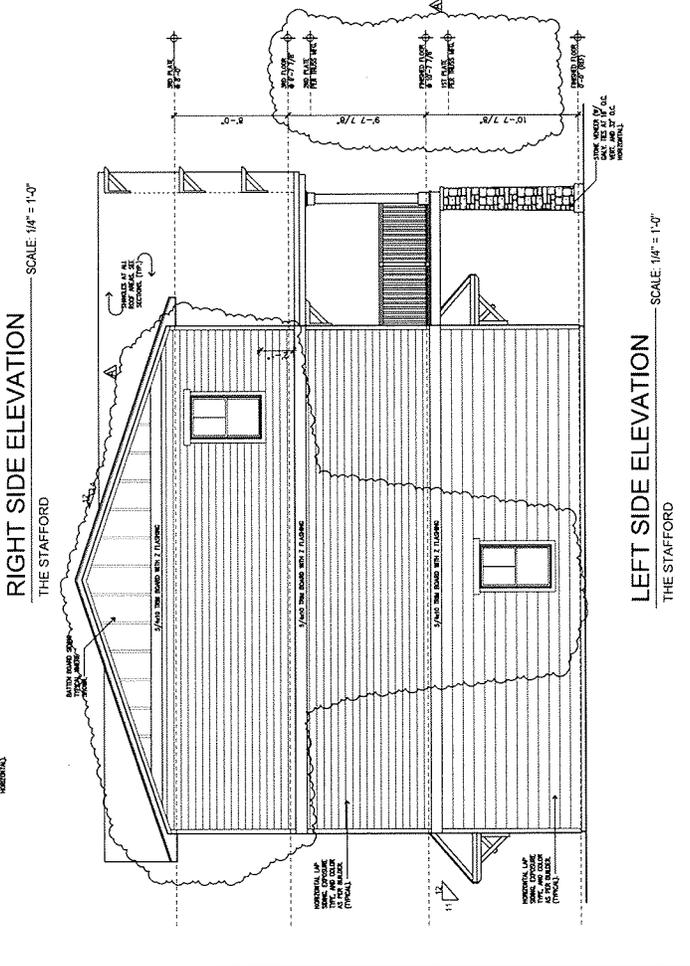


LEFT SIDE ELEVATION
THE STAFFORD
SCALE: 1/4" = 1'-0"


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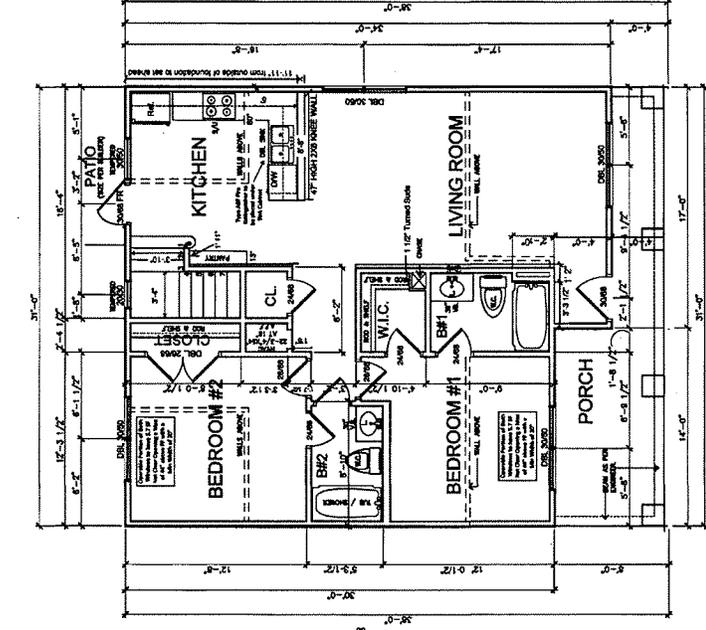
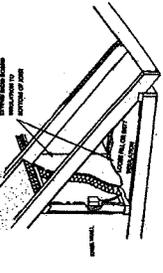
REAR ELEVATION - A
THE THORNBERRY
SCALE: 1/4" = 1'-0"



FRONT ELEVATION
THE THORNBERRY
SCALE: 1/4" = 1'-0"

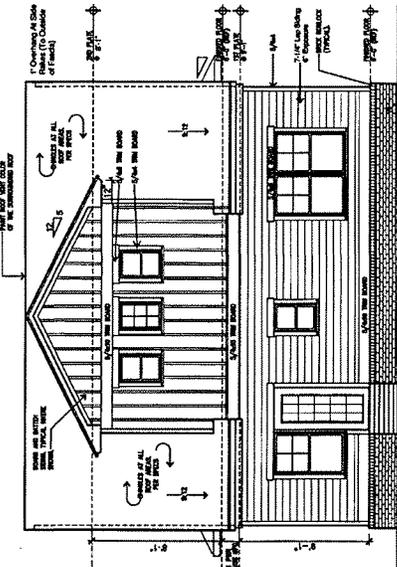
ATTN: SEE WALL ASSEMBLY

The Retreat - Unit Type #2	
S.F. - SHAKES EXTERIORS	
S.F. - COMBINATION AREA	
S.F. - FLOOR COVERING	200 S.F.
S.F. - WALL COVERING	1,000 S.F.
S.F. - FLOOR FINISH	1,000 S.F.
S.F. - FLOOR FINISH	1,000 S.F.

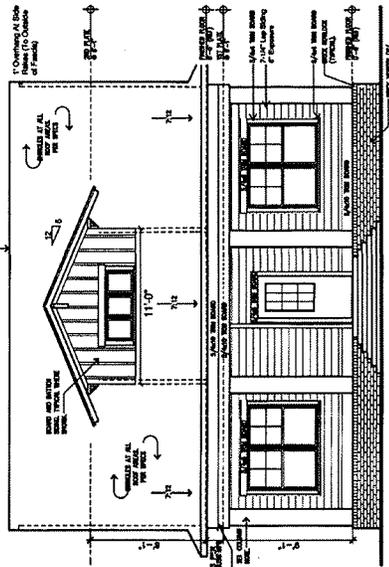

1ST FLOOR PLAN
THE THORNBERRY
SCALE: 1/4" = 1'-0"

- GENERAL NOTES:
1. ALL DIMENSIONS UNLESS OTHERWISE NOTED ARE TO FACE UNLESS SPECIFIED OTHERWISE.
 2. MATCHING 1/2\"/>

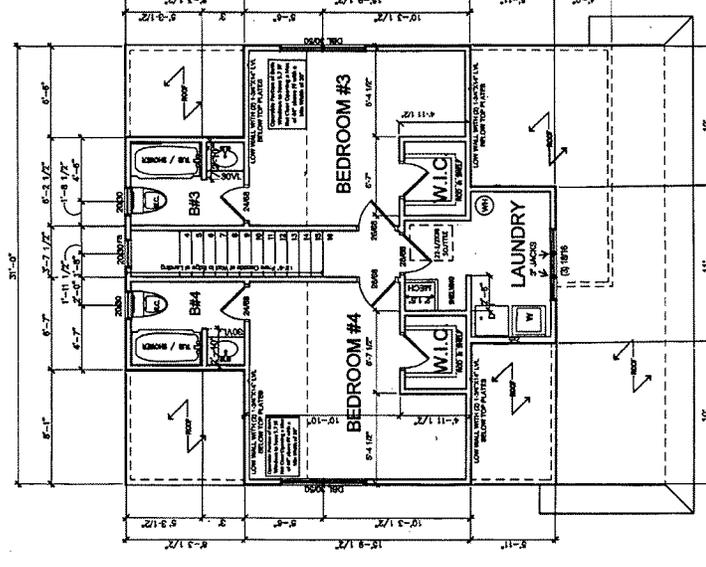

2ND FLOOR PLAN
THE THORNBERRY
SCALE: 1/4" = 1'-0"

- GENERAL NOTES:
1. ALL DIMENSIONS UNLESS OTHERWISE NOTED ARE TO FACE UNLESS SPECIFIED OTHERWISE.
 2. MATCHING 1/2\"/>

Note
All Window & Door
Headers are 83" Tall

Block Columns
are shown in red
and are to be
cast in place
concrete.

The Thornberry

