ORDINANCE NO.	

AN ORDINANCE OF THE CITY OF DENTON, TEXAS, APPROVING A DETAILED PLAN IN THE PLANNED DEVELOPMENT 174 (PD-174) ZONING DISTRICT TO CONSTRUCT AN AMENITY CENTER ON APPROXIMATELY 3.26 ACRES. THE SUBJECT SITE IS GENERALLY LOCATED ON THE SOUTHEAST SIDE OF JOHN PAINE ROAD, APPROXIMATELY 110 FEET NORTHEAST OF ATHENS DRIVE IN THE CITY OF DENTON, DENTON COUNTY, TEXAS; PROVIDING A SAVINGS CLAUSE; PROVIDING FOR A PENALTY IN THE MAXIMUM AMOUNT OF \$2,000.00 FOR VIOLATIONS THEREOF, SEVERABILITY AND AN EFFECTIVE DATE. (PDA16-0004).

WHEREAS, Applicant Stephen Gordon with Vintree & Associates ("Applicant") requests to develop approximately 3.26 acres of property located within the Country Lakes North Planned Development District (PD-174), generally located on the southeast side of John Paine Road, approximately 110 feet northeast of Athens Drive, in the City of Denton, Denton County, Texas, Country Lakes North Phase 3A 1 & 3B, Block P, Lot 19, and legally described in **Exhibit A** attached hereto and incorporated herein by reference (the "Property"); and

WHEREAS, PD-174 Zoning District was approved by the City Council on June 15, 1999 pursuant to Ordinance No. 99-205 to include 396.7 acres of land, which includes the Property; and

WHEREAS, Applicant requests the approval of a Detailed Plan for the Property in order to develop an amenity center on the Property, as depicted in $\underline{Exhibits\ B\ and\ C}$ attached hereto and incorporated herein by reference; and

WHEREAS, on August 10, 2016, after required notice, the Planning and Zoning Commission concluded a public hearing as required by law, and recommended approval of the Detailed Plan with conditions; and

WHEREAS, the City Council finds that the Amended Concept Plan is consistent with the plans for the entire PD-174 Zone and the Detailed Plan is consistent with the Concept Plan, which Concept Plan and Detailed Plan are both consistent with the Denton Plan 2030 and the Denton Development Code; NOW, THEREFORE

THE COUNCIL OF THE CITY OF DENTON HEREBY ORDAINS:

<u>SECTION 1.</u> The findings and recitations contained in the preamble of this ordinance are incorporated herein by reference and found to be true.

<u>SECTION 2.</u> Detailed Plan Adopted. The Detailed Plan for the Property is hereby approved as reflected in <u>Exhibits A, B, and C</u>, attached hereto and incorporated by reference, subject to the following conditions:

- 1. All original conditions of approval and subsequent modifications associated with PD-174 District shall remain valid, unless specified herein;
- 2. The Detailed Plan and Landscape Plan as submitted and shown in **Exhibits B and C** shall guide the development of the site; and

3. The elevation drawing and site details submitted and shown in Exhibit D shall guide the development of the site.
SECTION 4. Savings Clause. The provisions of this ordinance shall govern and control over any conflicting provisions of previously applicable ordinances. To the extent the previously applicable ordinances do not conflict or do not apply to the Property, those Ordinances shall continue in full force and effect.
SECTION 5. Amended PD. A copy of this ordinance shall be attached to Ordinance No. 99-205 showing the Detailed Plan herein approved, or attached to any other applicable ordinances as determined by the Director of Development Services, or his/her designee.
SECTION 6. Penalty. Any person, firm, entity or corporation violating any provision of this ordinance shall, upon conviction, be fined a sum not exceeding \$2,000.00 for each violation. Each day that a provision of this ordinance is violated shall constitute a separate and distinct offense. The penal provisions imposed under this Ordinance shall not preclude Denton from filing a civil suit to enjoin the violation and it retains all legal rights and remedies available under local State, and Federal law.
SECTION 7. Severability. If any provision of this Ordinance or the application thereof to any person or circumstance is held invalid by any court, such invalidity shall not affect the validity of the provisions or applications, and to this end the provisions of this Ordinance are severable.
SECTION 8. Effective Date. This ordinance shall become effective fourteen (14) days from the date of its passage, and the City Secretary is hereby directed to cause the caption of this ordinance to be published twice in the Denton Record-Chronicle, a daily newspaper published in the City of Denton, Texas, within ten (10) days of the date of its passage.
PASSED AND APPROVED this the day of, 2016.
CHRIS WATTS, MAYOR
ATTEST: JENNIFER WALTERS, CITY SECRETARY
DW

APPROVED AS TO LEGAL FORM: ANITA BURGESS, CITY ATTORNEY

BY:

Exhibit A Legal Description

Country Lakes North Phase 3A 1 and 3B, Block P, Lot 19.

PROPERTY.

(1,834.00 / 200 = 9 SPACES REQUIRED)

PROPOSED PARKING COUNT

HANDICAP PARKING SPACE

EXISTING FIRE HYDRANT

EXISTING SANITARY SEWER

1,834.00 SF

EXISTING STORM

RIGHT-OF-WAY

STOP SIGN

PROPOSED USE:

BUILDING AREA:

AT A MINIMUM.

STANDARDS

LOT COVERAGE: 1.1%

LAND AREA:

PROPOSED CURB INLET

BARRIER FREE RAMP

- NO PROTECTED TREES EXIST ON DEVELOPMENT SITE.
- THE PROPOSED BUILDING IS A NON AIR CONDITIONED SPACE, NO HVAC EQUIPMENT WILL BE LOCATED ON
- TRASH TOTES AND SWIMMING POOL EQUIPMENT SHALL BE SCREENED WITH 8'-0" HT. WOOD FENCE.
- LIGHTING FOR THE SUBJECT PROPERTY WILL BE CONSTRUCTED IN CONFORMANCE WITH TEXAS DEPARTMENT OF HEALTH REQUIREMENTS FOR COMMERCIAL SWIMMING FACILITIES.
- FOR ALL BARRIER FREE RAMPS NOTED ON PLAN, REFERENCE THE CITY OF DENTON STANDARD CONSTRUCTION DETAILS.
- REFER TO THE CITY OF DENTON TRANSPORTATION DESIGN CRITERIA MANUAL FOR PARKING LOT STRIPING WIDTHS AND COLORS.
- ALL STANDARD PARKING SPACES SHALL BE WHITE IN COLOR.
- ALL PARKING LOT DIMENSIONS SHOWN ARE FROM FACE OF CURB.

WATER METER SCHEDULE


METER	WATER	WATER	METER		SAN
ID NUMBER	SERVICE SIZE	METER SIZE	DOM.	IRR.	SERVI SIZI
1>	1.5"	1.5"	X		6"

OWNER / DEVELOPER: BLOOMFIELD HOMES, L.P. 1050 E. HWY 114


SUITE 210 SOUTHLAKE, TEXAS 7092 PH. (817) 416-1572


LANDSCAPE ARCHITECT:

CODY JOHNSON STUDIO, LLC 12217 CHATTANOOGA DR. FRISCO, TEXAS 75035 PH. (903) 570-0162 CONTACT: CODY JOHNSON, ASLA, LI

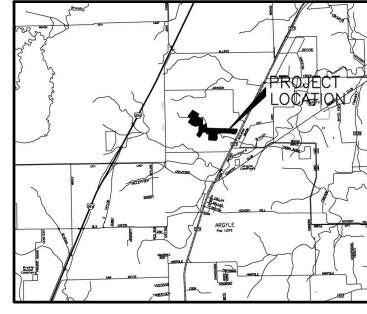

LOCATION MAP NOT TO SCALE

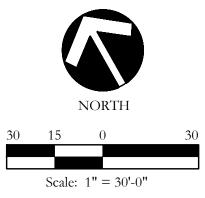

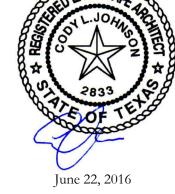

SITE PLAN COUNTRY LAKES NORTH PHASE 3A-B LOT 19, BLOCK P ~AMENITY CENTER~

3.826 ACRES IN OUT OF THE SPENCER GRAHAM SURVEY, ABSTRACT NO. 468, THE MARY SMITH SURVEY, ABSTRACT NO. 1181, AND THE WILLIAM SMITH SURVEY, ABSTRACT NO. 1182 IN THE

CITY OF DENTON, DENTON COUNTY, TEXAS

SUBMITTAL DATE: April 26, 2016 SP1


R20'-0" SAN. SEWER TEXOMA LANE SSMH · 5'-0" WIDTH CONCRETE SIDEWALK. TYP. UTILITY & DRAINAGE - BARRIER FREE RAMP CONCRETE ESMT. PER CITY OF DENTON SIDEWALK. TYP. REQUIREMENTS. BARRIER FREE RAMP PER CITY OF DENTON MONUMENT. REFER REQUIREMENTS. 208.261 ACRES TO DETAIL 1/L10 – 24" SOLID WHITE BAR BLOOMFIELD HOMES, L.P. MARKING WITH DOUBLE 4 C.C.# 2013-108870 INCH YELLOW STRIPING R.P.R.D.C.T. AND STOP SIGN. 8'-0" WIDTH CONCRETE TRAIL. — POOL EQUIP. 24" SOLID WHITE BAR -ENCLOSURE MARKING WITH DOUBLE 4 INCH YELLOW STRIPING TYPAND STOP SIGN. - I BARRIER FREE RAMP -PER CITY OF DENTON REQUIREMENTS. - 6'-0" HT. ORNAMENTAL METAL FENCE - 6'-0" WIDTH ` SWIMMING CONCRETE TRAIL DROP OFF PARKING - BIKE RACK (2) BOCCE BALL COURTS. - 15'x40' CEDAR SHADE 14.42 ACRES STRUCTURE DENTON I.S.D C.C.#2008-43036 R.P.R.D.C.T. - 3'-0" MAX. HT. PUTTING RETAINING WALL. GREEN REFER TO DETAIL 5/L6 MULTI-AGE PLAYGROUND SET 6'-0" WIDTH CONCRETE TRAIL. TYP. 12'x25' CEDAR SHADE STRUCTURE WITH (2) TABLES — SWING SET FACILITY 12'x25' CEDAR SHADE -LOT 19 STRUCTURE WITH (2) BLOCK P TABLES AND WATER AMENITY CENTER (3.826 ACRES) FOUNTAIN U-18 DOG SOCCER PARK - (2) BENCHES AND TRASH FIELD RECEPTACLE EA. SIDE UTILITY ESMT. 8'-0" WIDTH UTILITY & CONCRETE TRAIL. DRAINAGE ESMT. -------DOG PARK MAIN └─ 6'-0" WIDTH ENTRANCE AND EXIT. CONCRETE TRAIL. CREATE (2) 10'x10' ROOMS. TYP. ------SAN. SEWER — EXISTING WYE INLET TO REMAIN UTILITY ESMT. 6'-0" WIDTH ☐ DRAINAGE ESMT. CONCRETE TRAIL. COUNTRY LAKES NORTH PHASE TWO CAB. W, PG. 917 P.R.D.C.T. P DRAINAGE ESMT.

SAN. SEWER

SSMH


K.P.K.D.C.T.

-0004

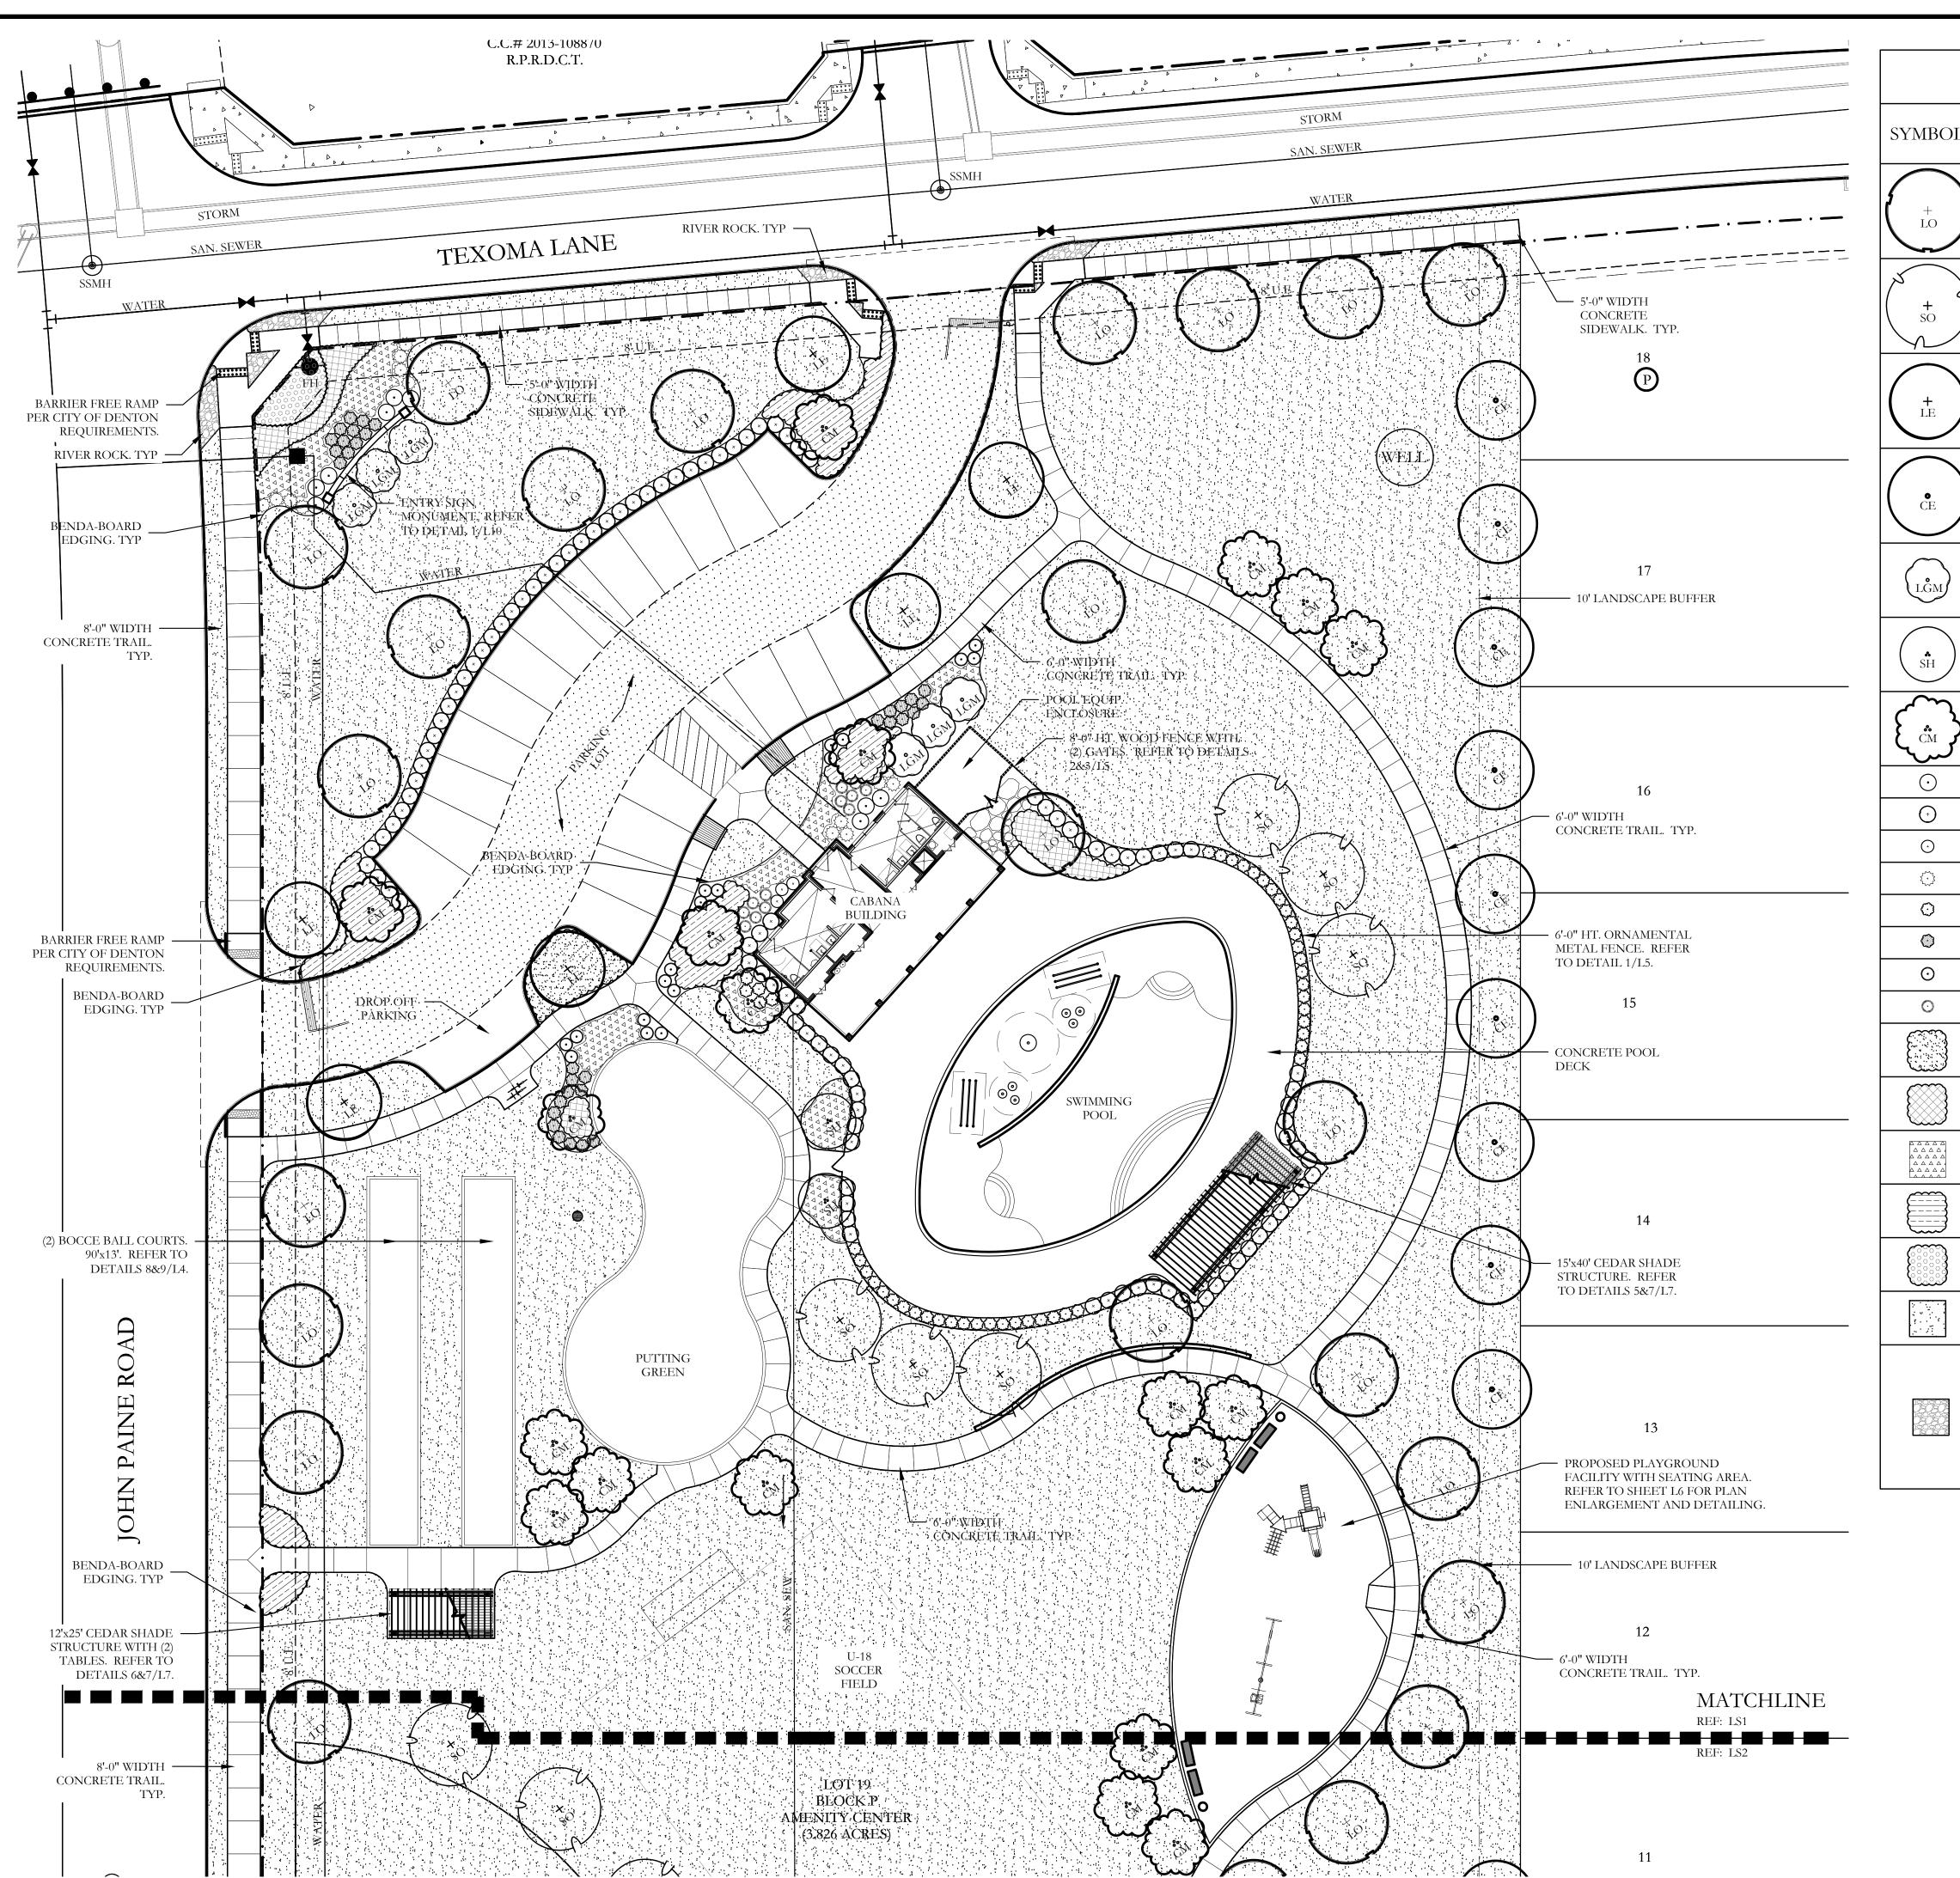

SYMBOL	KEY	COMMON NAME	SCIENTIFIC NAME	SIZE	SPACING
(LO	LO	LIVE OAK	QUERCUS VIRGINIANA	3" CALIPER	AS SHOWN
+ 50	SO	SHUMARD OAK	QUERCUS SHUMARDII	3" CALIPER	AS SHOWN
t _{LE}	LE	LACEBARK ELM	ULMUS PARVIFOLIA	3" CALIPER	AS SHOWN
© CE	CE	CEDAR ELM	ULMUS CRASSIFOLIA	3" CALIPER	AS SHOWN
LĠM	LGM	LITTLE GEM MAGNOLIA	MAGNOLIA GRANDIFLORA 'LITTLE GEM'	2" CALIPER	AS SHOWN
SH	SH	SAVANNAH HOLLY	ILEX X ATTENUATA 'SAVANNAH'	2" CALIPER	AS SHOWN
	СМ	MUSKOGEE CRAPE MYRTLE	LAGERSTROEMIA INDICA X FAURIEI 'MUSKOGEE'	2" CALIPER	AS SHOWN
<u>.</u>		PURPLE DIAMOND LOROPETALUM	LOROPETALUM CHINENSIS ' PURPLE DIAMOND' H.EV. CORNETAL DWARE	7 GALLON	48" O.C.
<u>+</u>		DWARF BURFORD HOLLY	ILEX CORNUTA' DWARF BURFORD'	5 GALLON	36" O.C.
⊙	<u> </u>	KNOCKOUT ROSE	ROSA SPP.	7 GALLON	36" O.C.
200 A	<u> </u>	MORNING LIGHT MISCANTHUS	MISCANTHUS SINENSIS 'MORNING LIGHT'	3 GALLON	36" O.C.
<u> </u>	<u> </u>	PINKIE INDIAN HAWTHORN	RHAPHIOLEPIS INDICA 'PINKIE'	3 GALLON	36" O.C.
0	<u> </u>	INDIAN HAWTHORN 'SNOW'	RHAPHIOLEPIS INDICA 'SNOW'	3 GALLON	36" O.C.
<u> </u>	<u> </u>	RED YUCCA	HESPERALOE PARVIFLORA	3 GALLON	36" O.C.
<u> </u>	<u> </u>	DWARF WAYMYRTLE	MYRICA SPP.	3 GALLON	36" O.C.
		GULF MUHLY GRASS	MUHLENBERGIA CAPILLARIS 'REGAL MIST'	1 GALLON	24" O.C.
		LIRIOPE GRASS	LIRIOPE MUSCARI	1 GALLON	12" O.C.
		TAM JUNIPER	JUNIPERUS SABINA 'TAMARISCIFOLIA'	3 GALLON	36" O.C.
		WEEPING LOVE GRASS	ERAGROSTIS CURVULA	1 GALLON	18" O.C.
(ANNUAL COLOR	TO BE SELECTED BY OWNER	4" POT	8" O.C.
2		COMMON BERMUDA GRASS	CYNODON DACTYLON	SQUARE FEET	SOLID SOD
		OKLAHOMA RIVER ROCK	3" DEPTH RIVER ROCK BED WITH LANDSCAPE FABRIC BENEATH AS SHOWN IN DETAILS. RIVER ROCK SHALL INCLUDE A MIXTURE OF TANS, BROWNS, GRAYS AND PINKS. RIVER ROCK SHALL BE AN EQUAL COMBINATION OF 1-2" AND 2-4" IN SIZE. REFER TO DETAIL 3/L3.	SQUARE FEET	100% COVERAGE

IOHNS Scale: 1'' = 20'-0''Bar is one inch on original drawing. If not one inch on this sheet, adjust scale as necessary. CENTER FACILITY CJS PROJECT NO. VIN003 SHEET NO. LS1 of 4

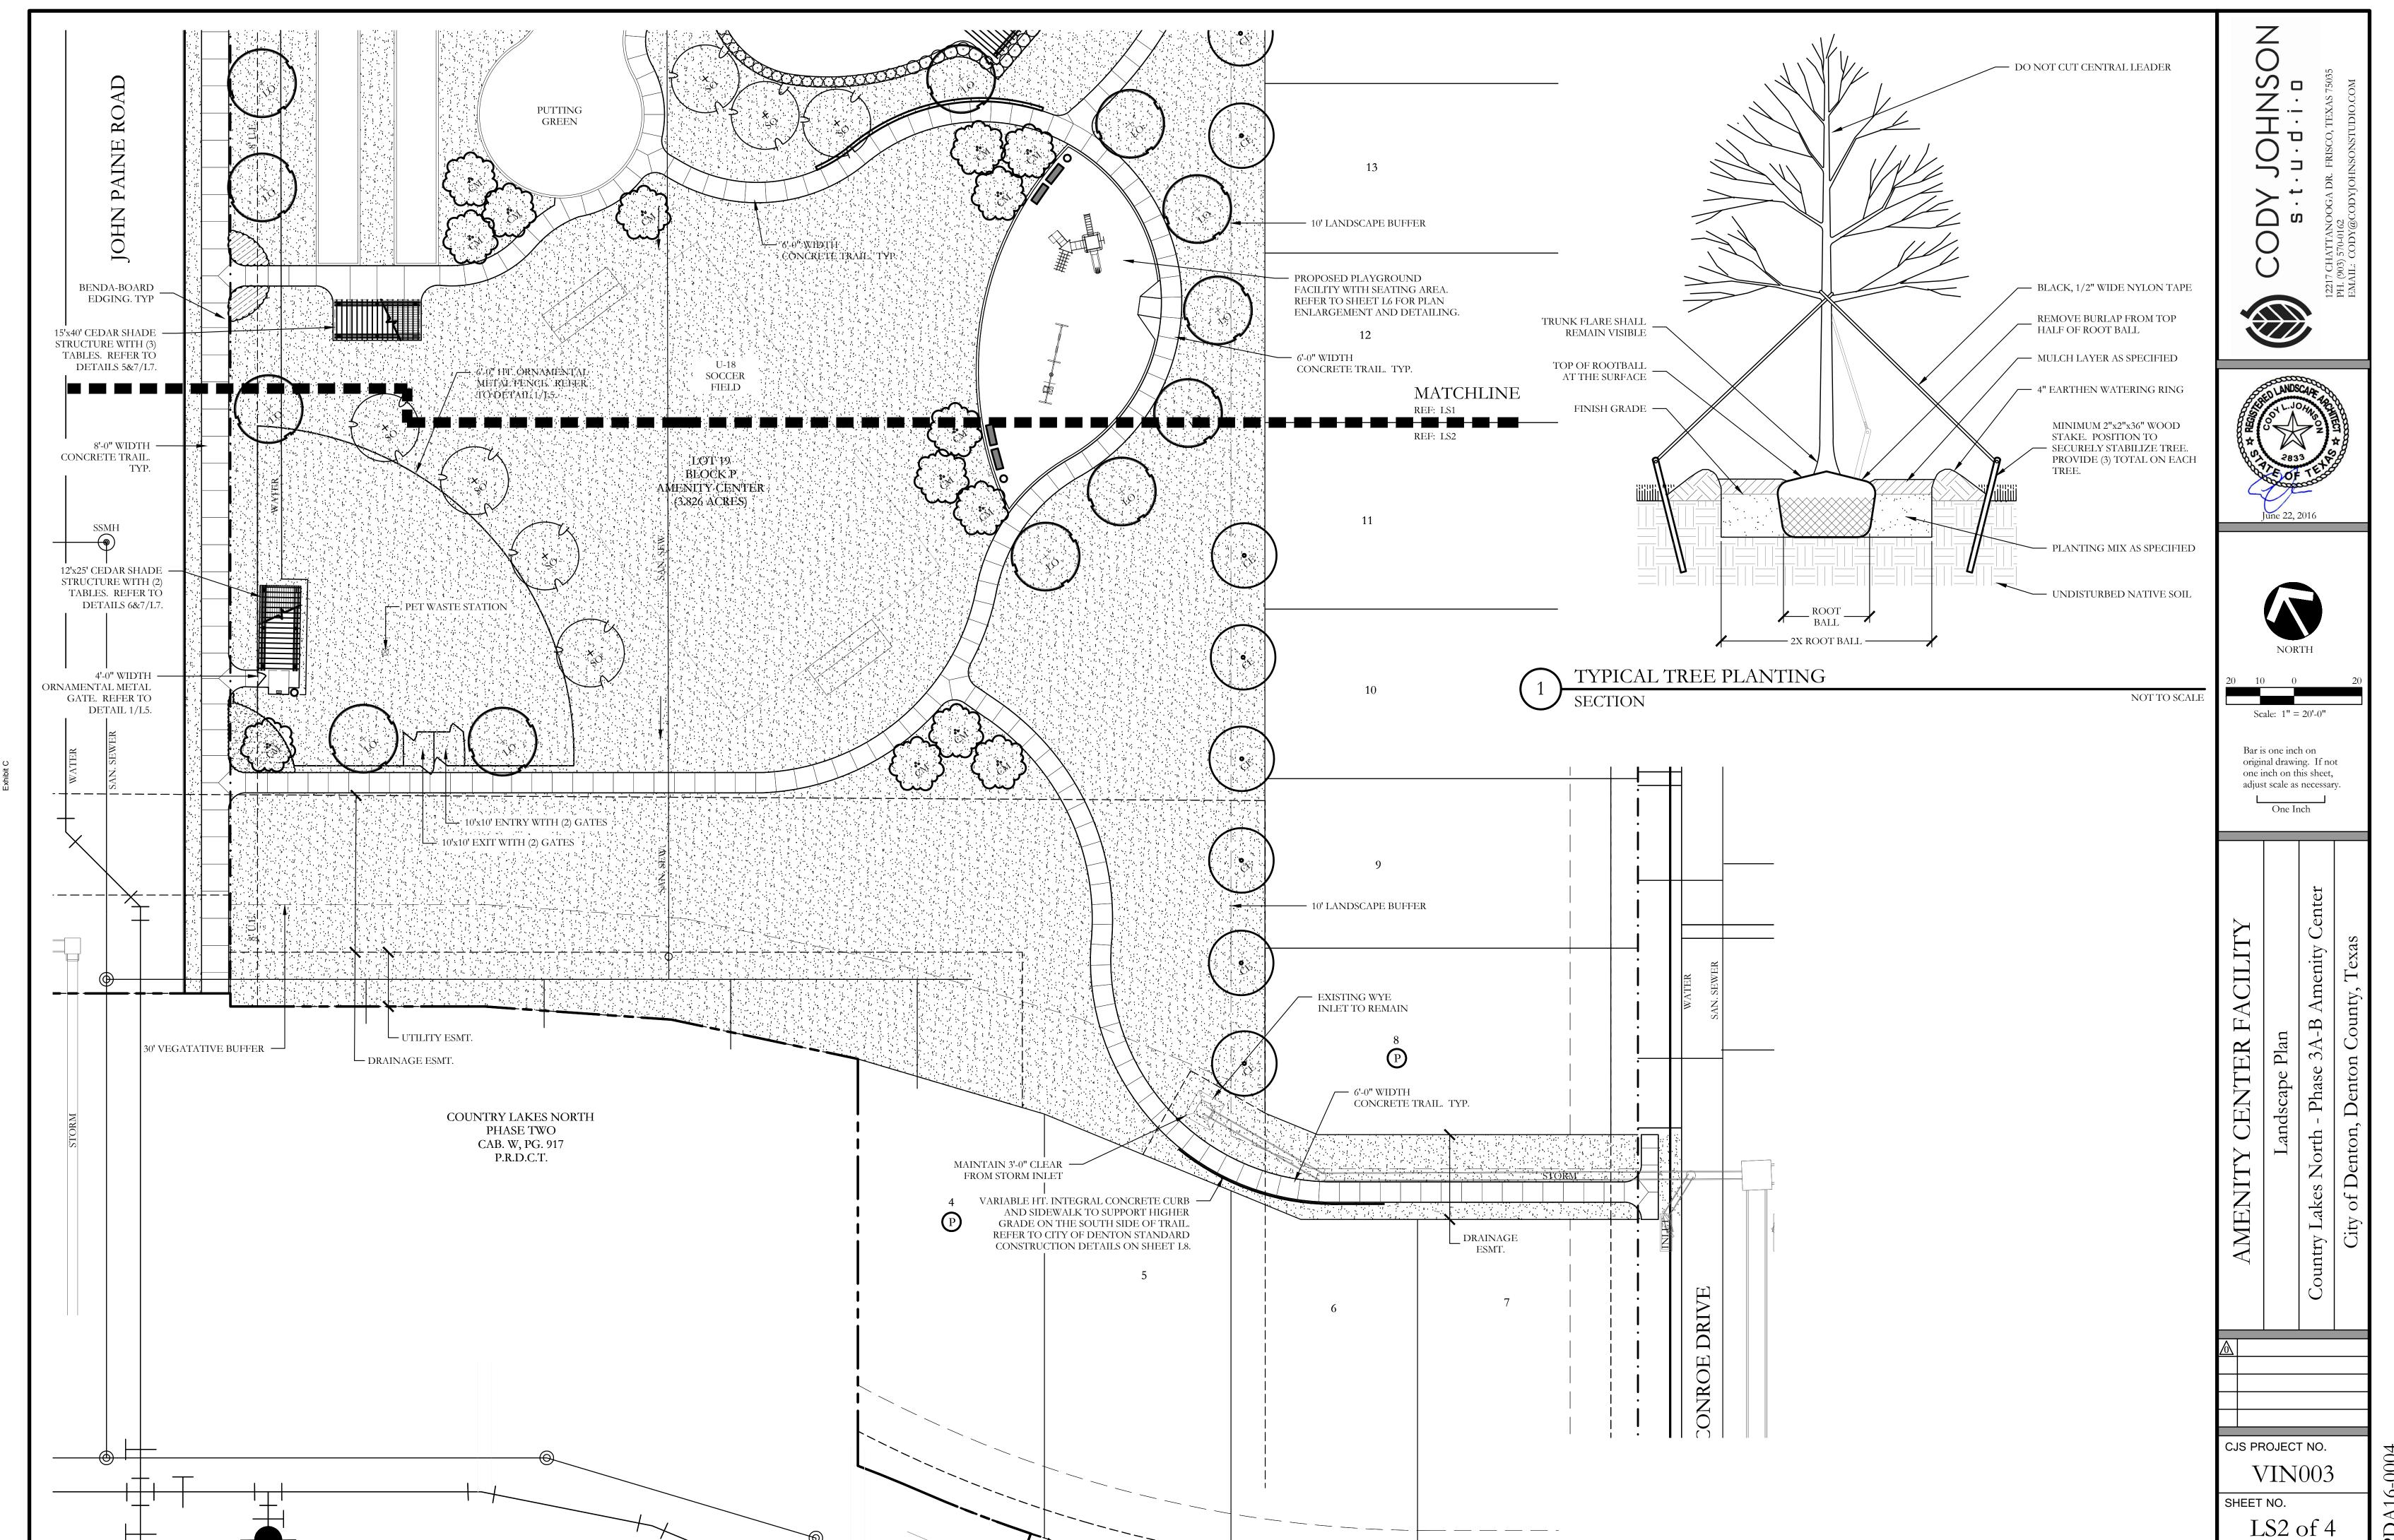

REQUIRED: 10'-0" WIDTH LANDSCAPE BUFFER WITH (1) ONE TREE PER 30 LINEAR FEET. PROVIDED: 10'-0" WIDTH LANDSCAPE BUFFER WITH (1) ONE TREE PER 30 LINEAR FEET ON EAST BOUNDARY LINE. WOOD FENCE WILL BE PROVIDED BY EACH HOMEOWNER ON EACH PRIVATE LOT.

REQUIRED: 30'-0" WIDTH LANDSCAPE BUFFER.

PROVIDED: 30'-0" WIDTH LANDSCAPE BUFFER ALONG SOUTHERN BOUNDARY LINE.

PARKING LOT LANDSCAPE PROVIDED:

- 1. GREATER THAN 7% OF THE TOTAL PARKING AREA IS PROPOSED TO BE LANDSCAPED WITH SHRUBS AND GROUNDCOVER.
- 2. GREATER THAN 15% OR 1,775 SQ. FT. OF THE REQUIRED PARKING IS PROPOSED TO BE COVERED WITH TREE CANOPY. (12 TREES PROVIDED WITH 12,912 TOTAL
- COVERAGE AT MATURE SPREAD) 3. SCREENING OF THE PARKING LOT IS PROVIDED BY PROPOSING A 3' HT. EVERGREEN HEDGE AND SHADE TREES PLANTED EVERY 40 LINEAR FEET BETWEEN THE PARKING LOT AND R.O.W.

PROPOSED USE: PRIVATE RECREATION CENTER

LAND AREA: 166,660.56 S.F. OR 3.26 ACRES

TOTAL SQUARE FEET OF IMPERVIOUS SURFACE: 44,960.56 S.F.

NO EXISTING TREES LIE WITHIN THE SITE.

TOTAL AREA OF NEW TREE CANOPY: 115,100 S.F. OR 70%

TOTAL LANDSCAPED OPEN AREAS: 121,700 S.F. OR 73%


TOTAL PARKING LOT AREA: 11,820 S.F. OR 7%

ALL LANDSCAPED AREAS SHALL BE IRRIGATED WITH AN AUTOMATIC IRRIGATION SYSTEM AS SHOWN ON IRRIGATION PLANS, THIS SET


MAX. 1" DOWN — TAPER PLANTING BED DOWN TO TOP OF EDGING FINISH GRADE MULCH LAYER AS SPECIFIED PLANTING MIX AS SPECIFIED 4" BENDA BOARD EDGING AS SPECIFIED PLASTIC EDGING STAKES @ 3'-0" O.C. MAX. WITH PLATED DECK SCREWS FOR ATTACHMENT, LOCATE ON PLANTING SIDE OF EDGE

TYPICAL BED EDGING DETAIL


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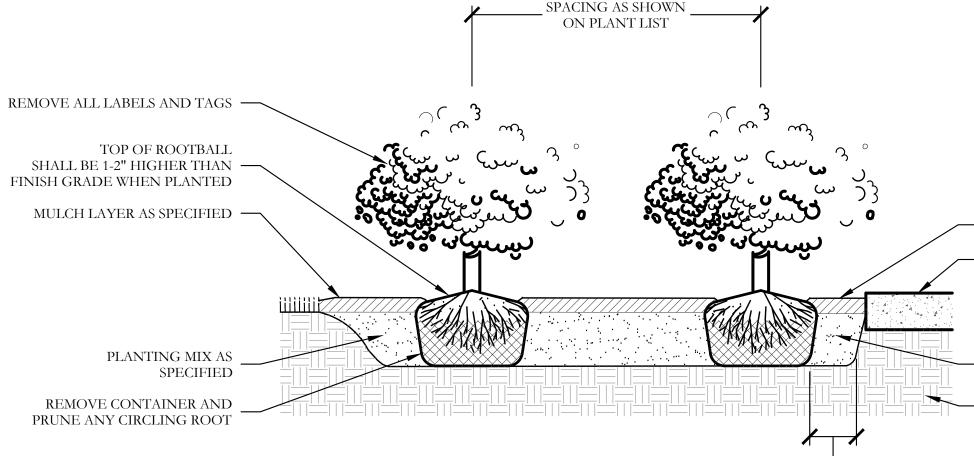
PLANT LIST **ESTIMATED** KEY COMMON NAME SCIENTIFIC NAME SIZE SPACING REMARKS QUANTITY NURSERY GROWN; FULL HEAD; MINIMUM BRANCHING QUERCUS VIRGINIANA LO LIVE OAK AS SHOWN 3" CALIPER 26 HEIGHT AT 6'-0"; MINIMUM 10'-0" OVERALL HEIGHT. NURSERY GROWN; FULL HEAD; MINIMUM BRANCHING SO **QUERCUS SHUMARDII** SHUMARD OAK 3" CALIPER AS SHOWN HEIGHT AT 6'-0"; MINIMUM 10'-0" OVERALL HEIGHT. NURSERY GROWN: FULL HEAD: MINIMUM BRANCHING LE LACEBARK ELM ULMUS PARVIFOLIA 3" CALIPER AS SHOWN HEIGHT AT 6'-0": MINIMUM 10'-0" OVERALL HEIGHT. NURSERY GROWN; FULL HEAD; MINIMUM BRANCHING CE 15 CEDAR ELM ULMUS CRASSIFOLIA 3" CALIPER HEIGHT AT 6'-0"; MINIMUM 10'-0" OVERALL HEIGHT. MAGNOLIA GRANDIFLORA NURSERY GROWN; FULL HEAD; MINIMUM 8'-0" LGM LITTLE GEM MAGNOLIA 2" CALIPER AS SHOWN 'LITTLE GEM' OVERALL HEIGHT. NURSERY GROWN; FULL HEAD; MINIMUM 8'-0" SH SAVANNAH HOLLY ILEX X ATTENUATA 'SAVANNAH 2" CALIPER AS SHOWN OVERALL HEIGHT. LAGERSTROEMIA INDICA X NURSERY GROWN; FULL HEAD; MINIMUM 8'-0" MUSKOGEE CRAPE MYRTLE 2" CALIPER AS SHOWN OVERALL HEIGHT FAURIEI 'MUSKOGEE' LOROPETALUM CHINENSIS' PURPLE DIAMOND CONTAINER GROWN; FULL PLANT. 7 GALLON 48" O.C. PURPLE DIAMOND' LOROPETALUM ILEX CORNUTA' DWARF CONTAINER GROWN; FULL PLANT. 105 DWARF BURFORD HOLLY 5 GALLON 36" O.C. BURFORD' CONTAINER GROWN; FULL PLANT. KNOCKOUT ROSE ROSA SPP. 7 GALLON 36" O.C. MORNING LIGHT MISCANTHUS SINENSIS 14 3 GALLON 36" O.C. CONTAINER GROWN; FULL PLANT. MISCANTHUS 'MORNING LIGHT' CONTAINER GROWN; FULL PLANT. 47 PINKIE INDIAN HAWTHORN RHAPHIOLEPIS INDICA 'PINKIE 3 GALLON 36" O.C. INDIAN HAWTHORN SNOW RHAPHIOLEPIS INDICA 'SNOW' 3 GALLON 36" O.C. CONTAINER GROWN; FULL PLANT. HESPERALOE PARVIFLORA 3 GALLON 36" O.C. CONTAINER GROWN; FULL PLANT. 18 RED YUCCA DWARF WAYMYRTLE 3 GALLON 36" O.C. CONTAINER GROWN; FULL PLANT. 12 MYRICA SPP. MUHLENBERGIA CAPILLARIS CONTAINER GROWN; FULL PLANT. 210 **GULF MUHLY GRASS** 1 GALLON 24" O.C. 'REGAL MIST' 500 LIRIOPE GRASS LIRIOPE MUSCARI 1 GALLON 12" O.C. CONTAINER GROWN; FULL PLANT. JUNIPERUS SABINA TAM JUNIPER CONTAINER GROWN; FULL PLANT. 130 3 GALLON 36" O.C. 'TAMARISCIFOLIA' 720 WEEPING LOVE GRASS ERAGROSTIS CURVULA 1 GALLON 18" O.C. CONTAINER GROWN; FULL PLANT. CONTAINER GROWN; FULL PLANT. ANNUAL COLOR TO BE SELECTED BY OWNER 4" POT 8" O.C. 450 117,000 COMMON BERMUDA GRASS CYNODON DACTYLON SOLID SOD MINIMUM 100% COVERAGE ALL AREAS SHOWN FEET " DEPTH RIVER ROCK BED WITH LANDSCAPE FABRIC BENEATH AS SHOWN IN DETAILS. RIVER ROCK SHALL INCLUDE A MIXTURE OF TANS, BROWNS, GRAYS AND SQUARE SOLID 270 OKLAHOMA RIVER ROCK COVERAGE PINKS. RIVER ROCK SHALL BE AN EQUAL FEET COMBINATION OF 1-2" AND 2-4" IN SIZE. REFER TO DETAIL 3/LS3.

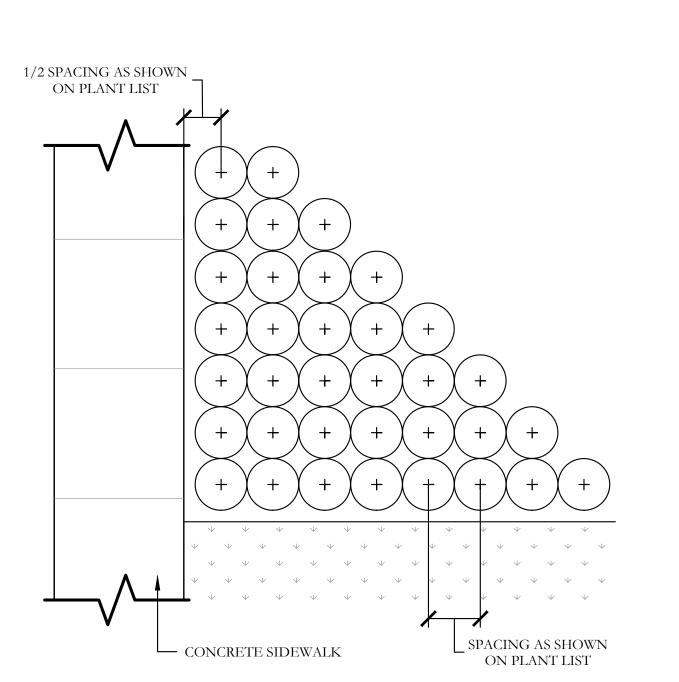

OKLAHOMA RIVER ROCK BED SCALE: 1'' = 1'-0'

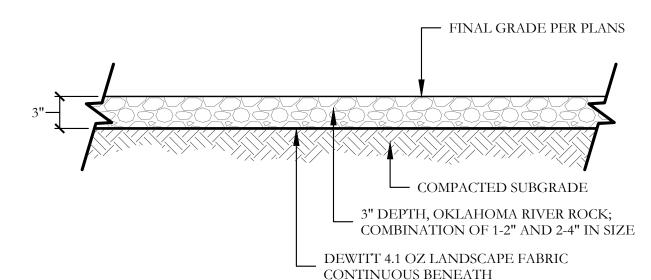

TRIANGULAR SPACING IS PREFERRED. USE SQUARE SPACING ONLY IN SMALL RECTILINEAR AREAS. "D" EQUALS THE SPACING DISTANCE AS SPECIFIED ON THE PLANT LEGEND.

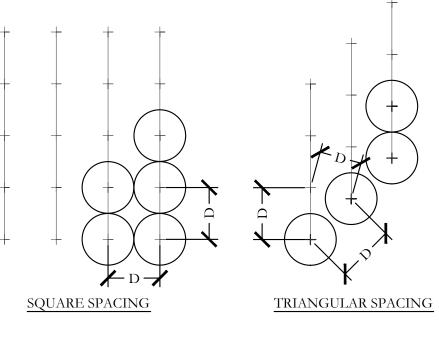

1/2 ROOTBALL DIAMETER -

TYPICAL SHRUB AND GROUNDCOVER PLANTING PLAN/SECTION

GENERAL LANDSCAPE NOTES

INSPECTIONS:

- . NO EXCAVATION SHALL OCCUR IN CITY R.O.W. WITHOUT A R.O.W. PERMIT--CONTACT THE PUBLIC WORKS DEPARTMENT.
- 2. THE CONTRACTOR SHALL MARK ALL WATER LINES, SEWER LINES, AND TREE LOCATIONS PRIOR TO CALLING FOR ROW INSPECTION AND PERMIT.
- 3. THE LANDSCAPE INSTALLATION SHALL COMPLY WITH APPROVED LANDSCAPE DRAWINGS PRIOR TO
- 4. WATER METERS, CLEANOUTS AND OTHER APPURTENANCES, SHALL BE ACCESSIBLE, ADJUSTED TO GRADE, CLEARLY MARKED WITH FLAGGING AND COMPLIANT WITH PUBLIC WORKS DEPARTMENT STANDARDS PRIOR TO CALLING FOR FINAL LANDSCAPE AND ROW INSPECTIONS.

FINAL ACCEPTANCE BY THE CITY AND ISSUANCE OF A CERTIFICATE OF OCCUPANCY.

LANDSCAPE STANDARDS:

- 1. PLANTINGS AND LANDSCAPE ELEMENTS SHALL COMPLY WITH THE CITY'S ENGINEERING DESIGN STANDARDS, PUBLIC R.O.W. VISIBILITY REQUIREMENTS.
- 2. UNLESS OTHERWISE SPECIFIED, TREES SHALL BE PLANTED NO LESS THAN 4' FROM CURBS, SIDEWALKS, UTILITY LINES, SCREENING WALLS AND OTHER STRUCTURES. THE CITY HAS FINAL APPROVAL FOR ALL
- 3. A MINIMUM THREE FEET (3') RADIUS AROUND A FIRE HYDRANT MUST REMAIN CLEAR OF LANDSCAPE PURSUANT TO THE FIRE CODE.
- 4. STREET TREES, WHERE REQUIRED, SHALL BE (10') MINIMUM FROM THE EDGE OF A STORM SEWER CURB INLET BOX AND THE EDGE OF THE ROOT BALL SHALL BE (4') MINIMUM FROM THE WATER METER.
- 5. THE AMERICAN STANDARD FOR NURSERY STOCK (ANSI Z60.1-2004) SPECIFICATIONS SHALL GOVERN
- PLANT OUALIFICATIONS, GRADES, AND STANDARDS. 6. TREE PLANTING SHALL COMPLY WITH DETAILS HEREIN AND THE INTERNATIONAL SOCIETY OF
- ARBORICULTURE (ISA) STANDARDS. 7. A 2-3" LAYER OF MULCH SHALL BE PROVIDED AROUND THE BASE OF THE PLANTED TREE. THE MULCH
- SHALL BE PULLED BACK 4" FROM THE TRUNK OF THE TREE. TREE PITS SHALL BE TESTED FOR WATER PERCOLATION. IF WATER DOES NOT DRAIN OUT OF TREE PIT
- WITHIN 24-HOURS, THE TREE SHALL BE MOVED OR DRAINAGE SHALL BE PROVIDED. 9. ALL BEDS TO HAVE 3" OF COMPOSTED SOIL, LIVING EARTH TECHNOLOGY, OR APPROVED EQUAL
- TILLED AND TURNED TO A DEPTH OF 8" MINIMUM. 10. ALL PLANT BEDS SHALL BE TOP-DRESSED WITH A MINIMUM OF 3 INCHES OF HARDWOOD MULCH.
- 11. NATIVE SITE TOPSOIL IS TO BE PROTECTED FROM EROSION OR STOCKPILED. NATIVE SITE TOPSOIL SHALL BE LABORATORY TESTED BY AND ACCREDITED LABORATORY AND AMENDED PER SAID LABORATORY'S RECOMMENDATIONS.

IRRIGATION STANDARDS:

- 1. ANY CHANGES TO THESE APPROVED IRRIGATION DRAWINGS SHALL BE AUTHORIZED BY THE CITY. CONTACT DEVELOPMENT SERVICES FOR AN IRRIGATION PERMIT PRIOR TO INSTALLING THE IRRIGATION SYSTEM.
- IRRIGATION OVER-SPRAY ON STREETS AND WALKS IS PROHIBITED
- MAINLINES, VALVES, OR CONTROL WIRES SHALL NOT BE LOCATED IN THE CITY'S ROW.
- ET IRRIGATION CONTROLLERS SHALL BE PROGRAMMED AND ADJUSTED TO NOT EXCEED THE LANDSCAPE WATER ALLOWANCE (LWA) PRIOR TO APPROVAL OF LANDSCAPE INSTALLATION.
- VALVES SHALL BE LOCATED A MINIMUM OF (3') AWAY FROM STORM SEWERS, AND SANITARY SEWER
- LINES AND 5 FEET FROM CITY FIRE HYDRANTS AND WATER VALVES. THE BORE DEPTH UNDER STREET'S, DRIVE AISLES, AND FIRE LANES SHALL PROVIDE (2') OF CLEARANCE
- IRRIGATION HEADS THAT RUN PARALLEL AND NEAR PUBLIC WATER AND SANITARY SEWER LINES; SHALL BE FED FROM STUBBED LATERALS OR BULL-BEADS. A MINIMUM FIVE FOOT (5') SEPARATION IS REQUIRED BETWEEN IRRIGATION MAIN LINES AND LATERALS THAT RUN PARALLEL TO PUBLIC WATER AND SANITARY SEWER LINES.
- 9. NO VALVES, BACKFLOW PREVENTION ASSEMBLIES, QUICK COUPLERS ETC. SHALL BE LOCATED CLOSER THAN 10' FROM THE CURB AT STREET OR DRIVE INTERSECTION.

MAINTENANCE STANDARDS:

THE OWNER SHALL BE RESPONSIBLE FOR THE ESTABLISHMENT, MAINTENANCE, AND VIGOR OF PLANT MATERIAL IN ACCORDANCE WITH THE DESIGN INTENT AND AS APPROPRIATE FOR THE SEASON OF

- LANDSCAPE AND OPEN AREAS SHALL BE FREE OF TRASH, LITTER AND WEEDS.
- 3. NO PLANT MATERIAL SHALL BE ALLOWED TO ENCROACH ON R.O.W., SIDEWALKS OR EASEMENTS TO FHE EXTENT THAT VISION OR ROUTE OF TRAVEL FOR VEHICULAR, PEDESTRIAN, OR BICYCLE TRAFFIC
- 4. TREE MAINTENANCE SHALL BE IN ACCORDANCE WITH THE STANDARDS OF THE INTERNATIONAL SOCIETY OF ARBORICULTURE.
- TREE STAKING MATERIALS, IF USED, SHALL BE REMOVED AFTER (1) GROWING SEASON, NO MORE
- THAN (1) YEAR AFTER INSTALLATION (STEEL TREE STAKES, WIRES, AND HOSES ARE PROHIBITED).

TREE PROTECTION NOTES:


- CONTACT DEVELOPMENT SERVICES FOR A TREE REMOVAL PERMIT PRIOR TO REMOVAL OR TRANSPLANTING OF ANY TREES.
- 2. ALL TREES WHICH ARE TO REMAIN ON SITE SHALL BE PROTECTED WITH A (4') TALL BRIGHTLY
- COLORED PLASTIC FENCE, OR SILT FENCE, PLACED AT THE DRIP LINE OF THE TREES PRIOR TO THE PRE-CONSTRUCTION MEETING OR OBTAINING A GRADING PERMIT, ALL TREE
- MARKINGS AND PROTECTIVE FENCING SHALL BE INSTALLED BY THE OWNER AND BE INSPECTED BY
- 4. NO EQUIPMENT SHALL BE CLEANED, OR HARMFUL LIQUIDS DEPOSITED WITHIN THE LIMITS OF THE ROOT ZONE OF TREES WHICH REMAIN ON SITE
- NO SIGNS, WIRES, OR OTHER ATTACHMENTS SHALL BE ATTACHED TO ANY TREE TO REMAIN ON SITE. VEHICULAR AND CONSTRUCTION EQUIPMENT SHALL NOT PARK OR DRIVE WITHIN THE LIMITS OF THE
- GRADE CHANGES IN EXCESS OF 3 INCHES (CUT OR FILL) SHALL NOT BE ALLOWED WITHIN A ROOT ZONE, UNLESS ADEQUATE TREE PRESERVATION METHODS ARE APPROVED BY THE CITY.
- 8. NO TRENCHING SHALL BE ALLOWED WITHIN THE DRIP-LINE OF A TREE, UNLESS APPROVED BY THE
- 9. ALL REMOVED TREES SHALL BE CHIPPED AND USED FOR MULCH ON SITE OR HAULED OFF-SITE.
- 10. ALL TREE MAINTENANCE TECHNIQUES SHALL BE IN CONFORMANCE WITH INDUSTRY IDENTIFIED STANDARDS. IMPROPER OR MALICIOUS PRUNING TECHNIQUES ARE STRICTLY PROHIBITED.



NOT TO SCALE

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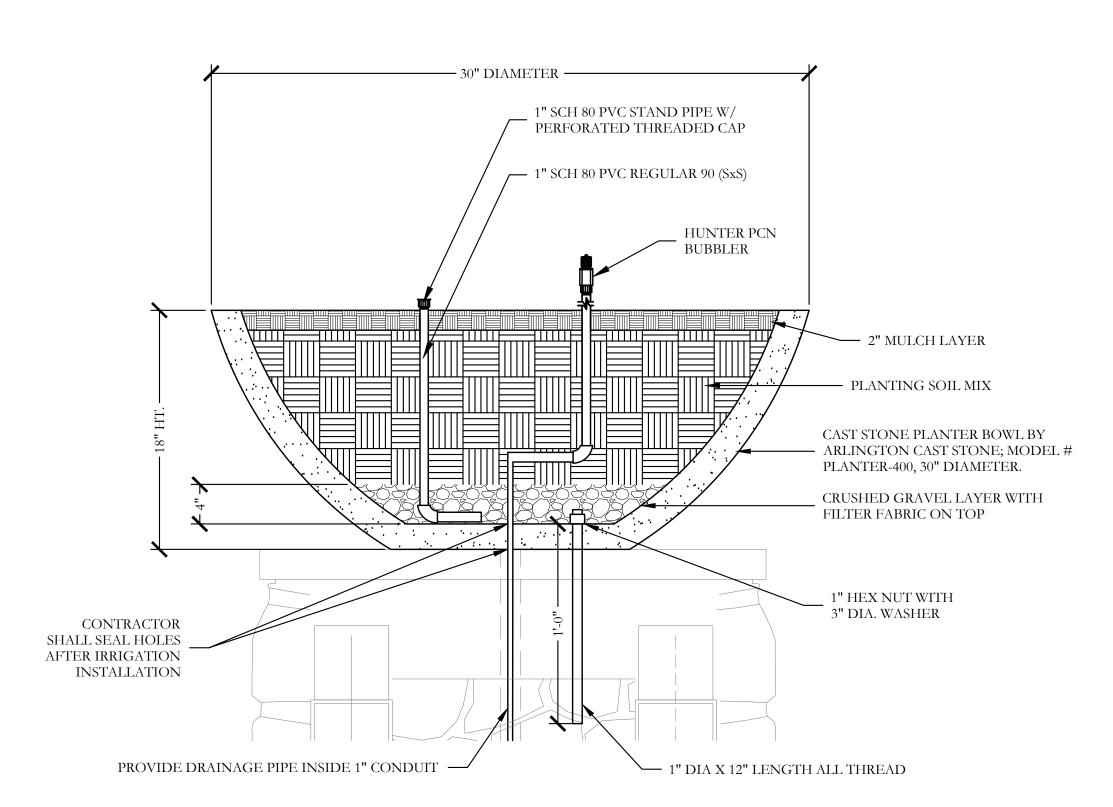


Bar is one inch on original drawing. If not one inch on this sheet, adjust scale as necessary.
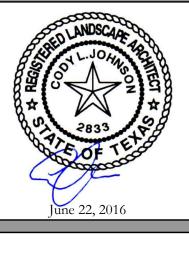
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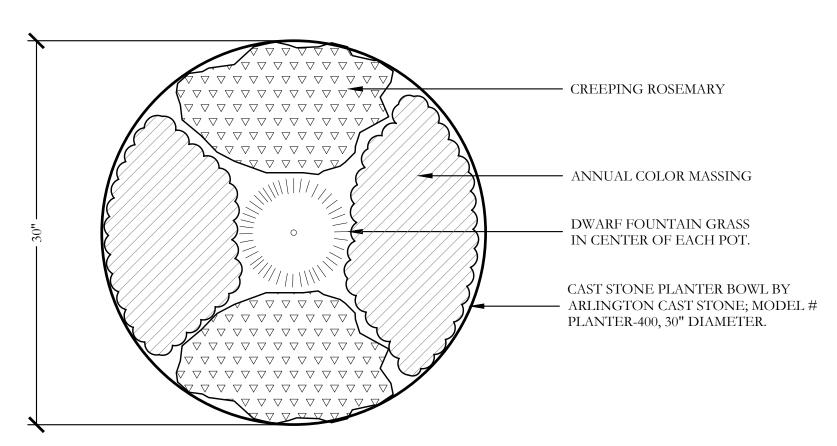
CJS PROJECT NO. VIN003

SHEET NO. LS3 of



TYPICAL LANDSCAPE POTTERY DETAIL ATOP COLUMN

NOT TO SCALE



LANDSCAPE POTTERY PLANTING LAYOUT

NOT TO SCALE

LANDSCAPE POTTERY PLANT LIST							
SYMBOL	ESTIMATED QUANTITY	COMMON NAME	SCIENTIFIC NAME	SIZE	SPACING	REMARKS	
	2	DWARF FOUNTAIN GRASS	PENNISETUM ALOPECUROIDES 'HAMELN'	2 GALLON	CENTER OF POT	CONTAINER GROWN; FULL PLANT.	
	16	ANNUAL COLOR	TO BE SELECTED BY OWNER	4" POT	8" O.C.	CONTAINER GROWN; FULL PLANT.	
	4	CREEPING ROSEMARY	ROSMARINUS OFFICINALIS 'PROSTRATUS'	1 GALLON	12" O.C.	CONTAINER GROWN; FULL PLANT.	
	2	CAST STONE PLANTER BOWL BY ARLINGTON CAST STONE; MODEL # PLANTER-400, 30" DIAMETER.					

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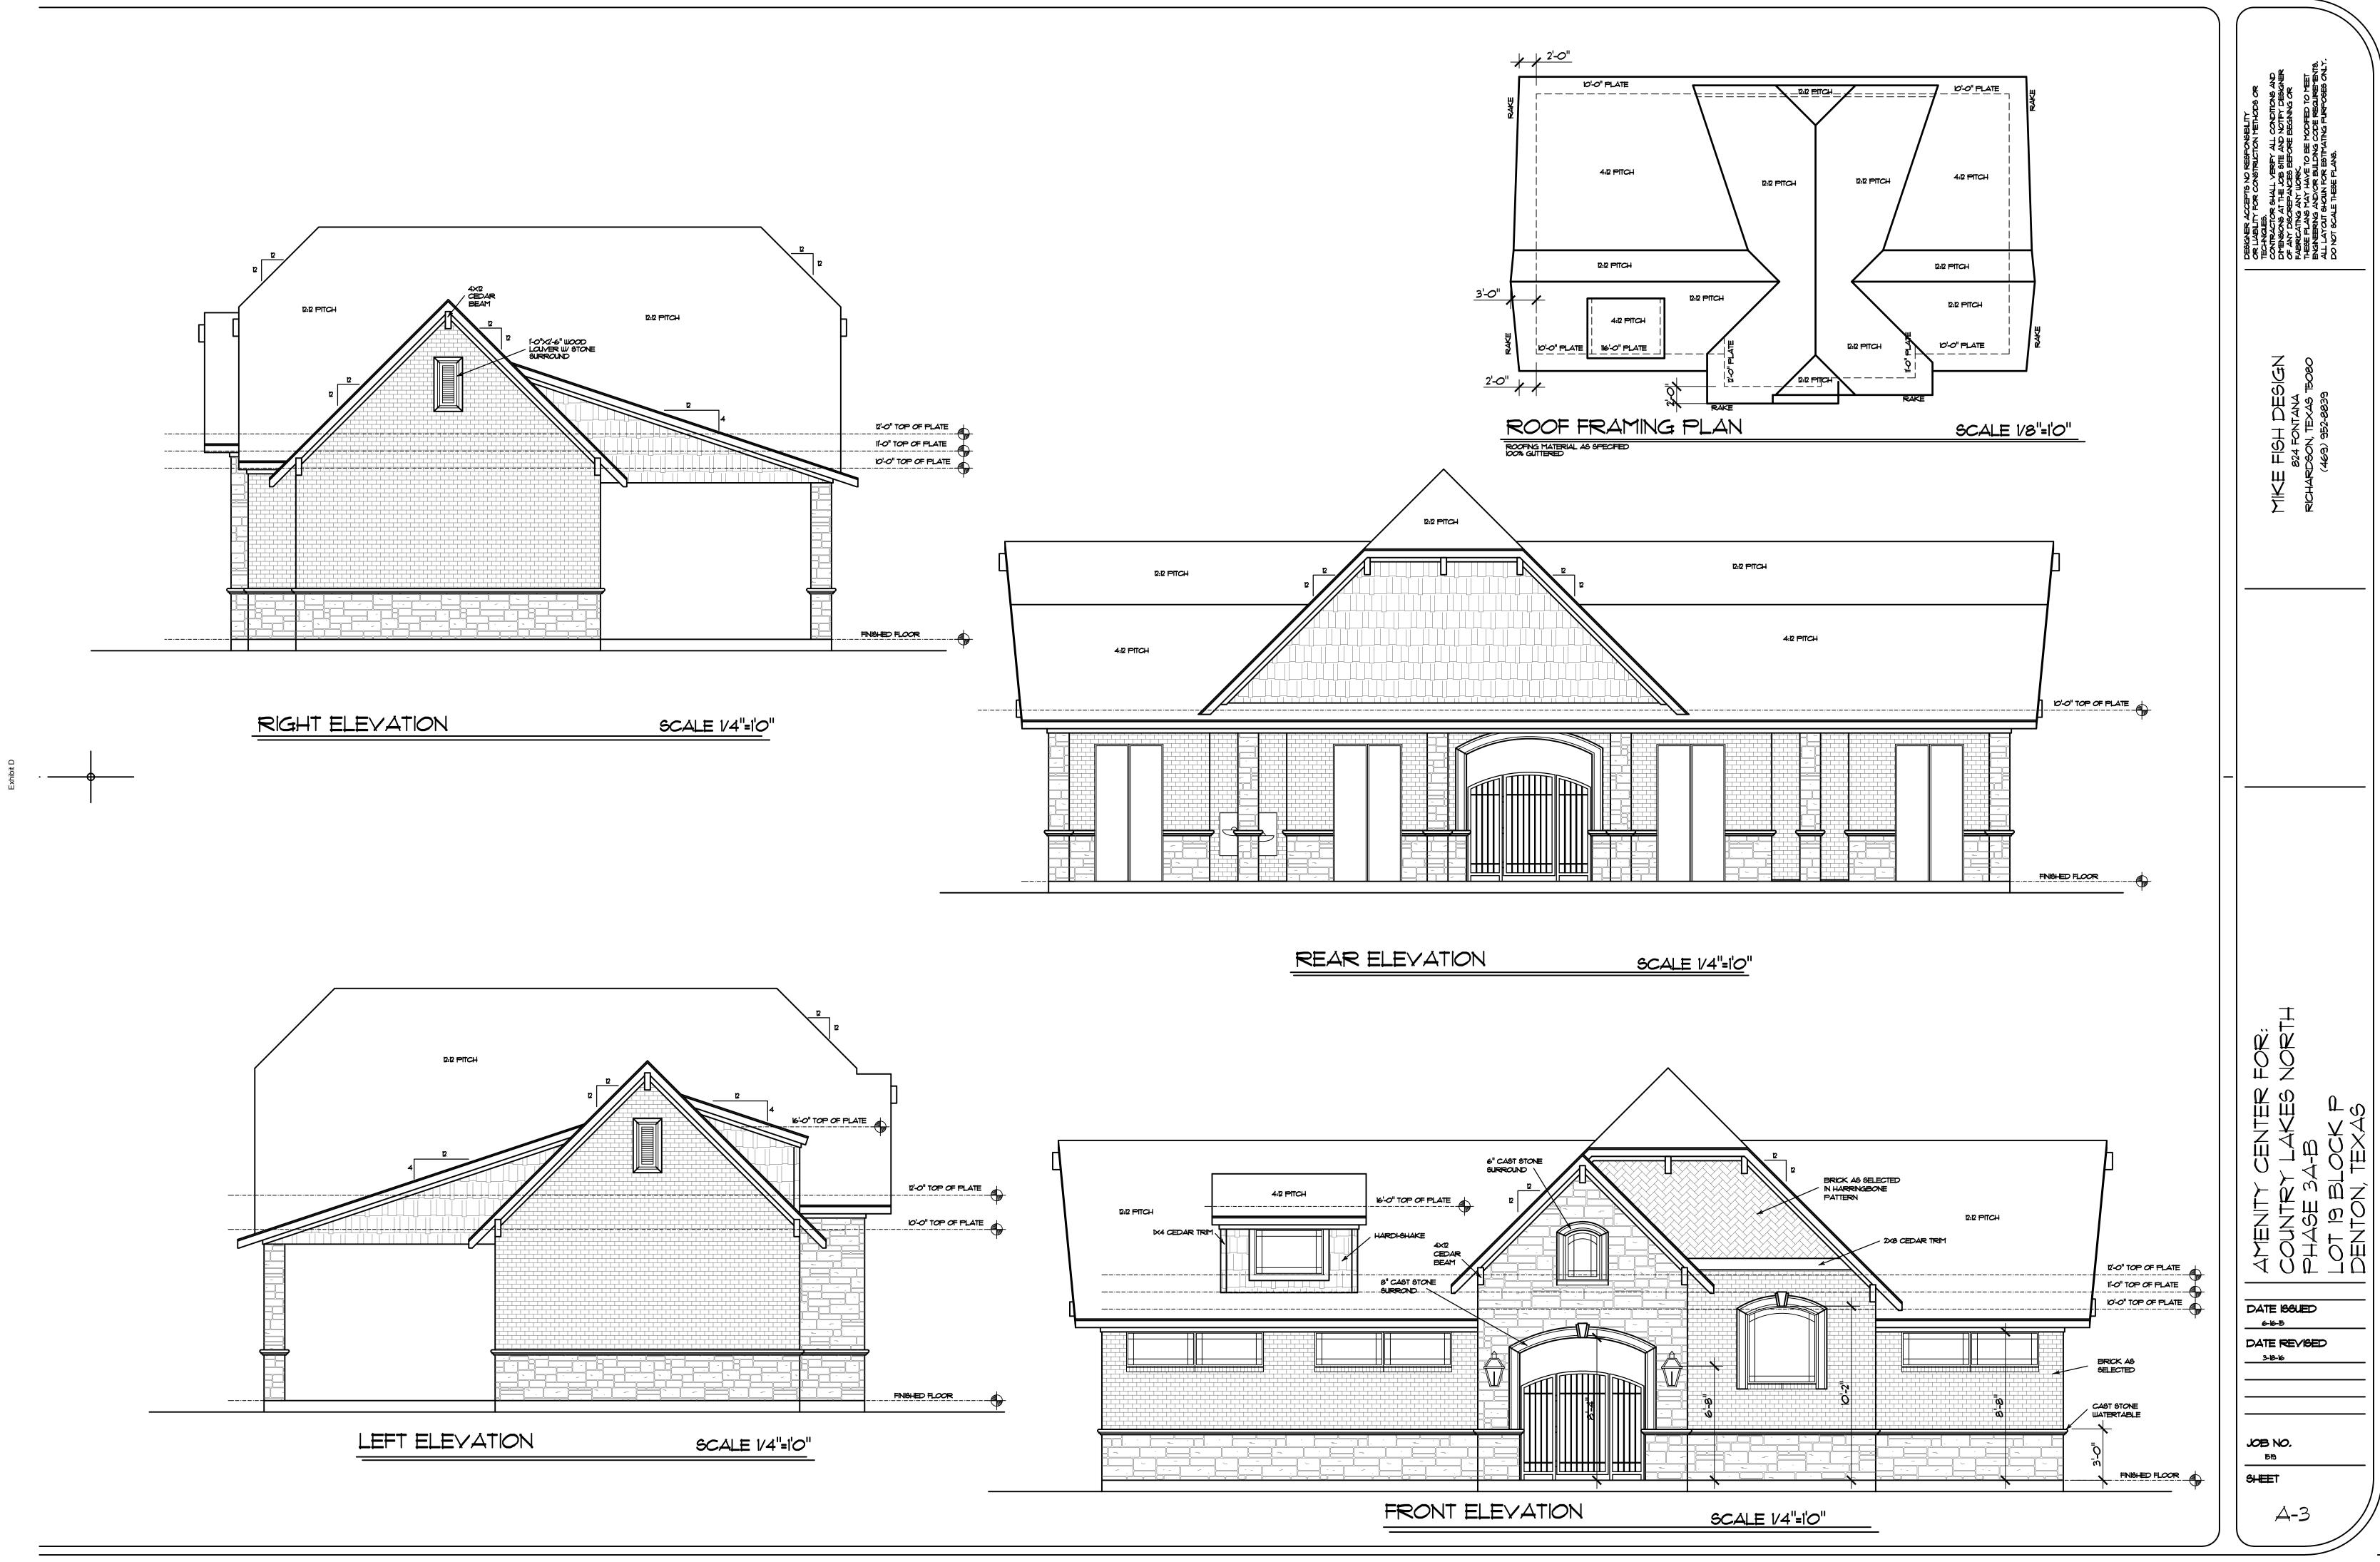
Bar is one inch on original drawing. If not one inch on this sheet, adjust scale as necessary.

AMENITY CENTER FACILITY

CJS PROJECT NO. VIN003

SHEET NO.

LS4 of <u>4</u>







Bar is one inch on original drawing. If not one inch on this sheet, adjust scale as necessary.

CENTER

CJS PROJECT NO. VIN003

-0004

16-

PD,

SHEET NO.

FENCE LAYOUT NOTES

- 1. THE CONTRACTOR IS RESPONSIBLE FOR MAKING HIMSELF FAMILIAR WITH ALL UNDERGROUND UTILITIES, PIPE AND STRUCTURES WHETHER OR NOT SHOWN ON THE PLANS. THE CONTRACTOR SHALL BE RESPONSIBLE FOR LOCATION OF ALL UNDERGROUND UTILITIES AND WILL BE RESPONSIBLE FOR COSTS INCURRED DUE TO DAMAGE OR REPLACEMENT OF SAID UTILITIES OR STRUCTURES CAUSED BY HIS FORCES.
- DO NOT WILLFULLY PROCEED WITH CONSTRUCTION. AS DESIGNED. WHEN IT IS OBVIOUS THAT UNKNOWN OBSTRUCTIONS OR CONFLICTS EXIST THAT MAY NOT HAVE BEEN KNOWN DURING DESIGN. SUCH CONDITIONS SHALL BE BROUGHT IMMEDIATELY TO THE ATTENTION OF THE LANDSCAPE ARCHITECT. THE CONTRACTOR SHALL ASSUME FULL RESPONSIBILITY FOR ALL NECESSARY REVISIONS DUE TO FAILURE TO GIVE SUCH NOTIFICATION.
- 3. THE CONTRACTOR SHALL BE RESPONSIBLE FOR THE LAYOUT OF THE PROPOSED WALLS AND COLUMNS. THE OWNER'S ENGINEER SHALL STAKE THE LOCATIONS OF THE PROPERTY, R.O.W. LINES AND EASEMENTS.
- 4. THE CONTRACTOR SHALL STAKE ALL OF THE FENCE AND COLUMN LOCATIONS FOR REVIEW BY THE OWNER'S REPRESENTATIVE PRIOR TO BEGINNING CONSTRUCTION. THE OWNER'S REPRESENTATIVE MAY MAKE MINOR ALTERATIONS TO THE LAYOUT AFTER STAKING AND BEFORE CONSTRUCTION AT NO ADDITIONAL COST TO THE OWNER.
- 5. ALL "STEPS" IN THE WALL MADE NECESSARY BY GRADE CHANGES OR EXISTING SLOPE SHALL OCCURR ONLY AT MINOR OR MAJOR COLUMNS. THE MINIMUM "STEP" AT A COLUMN SHALL BE 3" AND THE MAXIMUM "STEP"
- 6. ALL ELECTRICAL WORK SHALL BE PERFORMED BY A LICENSED ELECTRICIAN AND SHALL BE PERFORMED IN
- ACCORDANCE WITH ALL APPLICABLE CODES AND REQUIREMENTS. THE ELECTRICAL WORK SHALL INCLUDE ALL NECESSARY CONDUITS, WIRE, FITTINGS, FIXTURES TRENCHING AND OTHE MISCELLANEOUS ITEMS NECESSARY TO COMPLETE THE WORK.
- 8. THE CONTRACTOR SHALL BE RESPONSIBLE FOR ALL NECESSARY PERMITS AND CITY ACCEPTANCE.
- 9. THE CONTRACTOR SHALL BE RESPONSIBLE FOR GRADING AS NEEDED FOR FENCE AND COLUMN INSTALLATION. THE CONTRACTOR SHALL RETURN THE SITE TO PRE-CONSTRUCTION CONDITION.

WOOD FENCE NOTES

- 1. THE CONTRACTOR IS RESPONSIBLE FOR MAKING HIMSELF FAMILIAR WITH ALL UNDERGROUND UTILITIES, PIPES, AND STRUCTURES EITHER SHOWN OR NOT SHOWN ON THE PLANS. THE CONTRACTOR WILL BE RESPONSIBLE FOR ANY COST INCURRED DUE TO DAMAGE OR REPLACEMENT OF SAID UTILITIES AND STRUCTURES CAUSED BY HIS FORCES VERIFY LOCATION OF ALL UTILITIES WITH THE TOWN AND VARIOUS UTILITY COMPANIES BEFORE DRILLING PIERS.
- 2. ALL CONCRETE USED IN FOOTINGS SHALL HAVE A MINIMUM COMPRESSIVE STRENGTH OF 3,000 PSI @ 28
- 3. THE CONTRACTOR IS RESPONSIBLE FOR ALL NECESSARY AND REQUIRED PERMITS AND INSPECTIONS. CONSTRUCTION SHALL BE IN ACCORDANCE WITH CITY OF DENTON CODES AND REQUIREMENTS.
- 4. WOOD MATERIAL FOR FENCE 4.1. STRINGERS-CEDAR, #2 GRADE OR BETTER.

- 2" X 2" TUBULAR

3 EA. 90degree HINGES

(SELF CLOSING)

FINISH GRADE

4'-0" SELF CLOSING

SELF LATCHING GATE

FINISH GRADE

SOUARE STEEL POST

2" X 2" TUBE RAILS AT TOP,

(TYPICAL)

— 3/4" SQ. TUBULAR STEEL

SCALE: 1/2"= 1'-0"

PICKET @ 4" O.C. MAX

MIDDLE AND BOTTOM

- 4.2. PICKETS-CEDAR, #2 GRADE OR BETTER.
- 4.3. CAPS- CEDAR, #2 GRADE OR, BETTER
- 5. ALL FENCE POST TO BE SCHEDULE 40 GALVANIZED.
- ALL FASTENERS, NAILS, BRACKETS, STEEL POSTS, ETC.. ARE TO BE HOT DIPPED GALVANIZED.
- ALL PICKETS ARE TO BE FASTENED TO THE RAILS USING GALVANIZED SCREWS. STAPLES AND/OR NAILS WILL NOT BE ALLOWED. SCREW WITHOUT SPLITTING MEMBERS; DRILL PILOT HOLES IF NECESSARY. ALL SPLIT MEMBERS WILL BE REQUIRED TO BE REPLACED AT NO ADDITIONAL COST TO THE OWNER.
- 8. ACCURATELY CUT, FIT FASTEN MEMBERS, MAKE PLUMB, LEVEL, TRUE, AND RIGID. DO NOT SPLICE INDIVIDUAL FRAMING MEMBERS BETWEEN SUPPORTS. ERECT FACES OF FRAMING MEMBERS IN STRAIGHT EVEN PLANES TO RECEIVE FINISH MATERIALS. INSTALL STRINGERS WITH BOTTOM EDGES FREE OF DEFECTS. MITER ALL EXPOSED FINISHED JOINTS.
- 9. REMOVE ALL MARKS, STAMPS, DIRT, LOOSÉ FIBERS FROM ALL WOOD SURFACES.
- 10. CONTRACTOR IS RESPONSIBLE FOR OBTAINING ALL REQUIRED PERMITS.

St. Louis, MO 63141 800.231.1327 tel.| 314.754.0835 fax specify@anovafurnishings.com anovafurnishings.com

211 North Lindbergh Blvd

AL19BR2— Allure Bike Rack, 2-bike capacity

Cast aluminum bike rack, surface mount

Surface mounting is required; mounting hardware is not included.

STRUCTURES CAUSED BY HIS FORCES.

9. FENCE MEMBER SIZES TO BE AS FOLLOWS:

OWNER FOR MATERIALS AND/OR LABOR.

9.1. PICKETS, 3/4" SQUARE 16 GA.

10. POSTS, 2" SQUARE 11 GA.

9.2. RAILS, 2" X 2" SOLID FLAT 16 GA.

FENCE.

3. THE CONTRACTOR IS RESPONSIBLE FOR ALL REQUIRED PERMITS AND CITY INSPECTIONS.

SPURS, AND SHARP EDGES AND SHALL BE INSTALLED LEVEL, PLUMB, AND SQUARE.

CONTRACTOR TO BE RESPONSIBLE FOR STRUCTURAL DESIGN OF GATES.

16. RESTRICTIVE MESH SHALL HAVE NO OPENINGS GREATER THAN 1/2" AND SHALL

4. ALL ORNAMENTAL METAL TUBES, POSTS, RAILS AND PICKETS SHALL BE FLUSH AND FREE OF ALL DENTS,

6. ALL METAL SURFACES SHALL BE PRIMED AND PAINTED WITH TWO COATS OF URBANE BRONZE (SW7048) BY

7. CONTRACTOR IS RESPONSIBLE FOR VERIFYING ALL DIMENSIONS BEFORE MANUFACTURING GATES AND

8. ALL ORNAMENTAL METAL FENCE MEMBERS ARE TO BE TUBULAR MEMBERS IN ACCORDANCE WITH ASTM 513

11. CONTRACTOR TO PROVIDE SHOP DRAWINGS FOR ALL FENCE GATES AND OPENERS. SHOP DRAWINGS SHALL

B561DBD626 SATIN CHROME DANE SFIC CLASSROOM LOCK BY A&H TURF. DEADLOCKING LATCH BOLT BY

14. POOL FENCE SHALL MEET LOCAL CODES AND REQUIREMENTS. CONTRACTOR SHALL BE RESPONSIBLE FOR

ENSURING COMPLIANCE INCLUDING NECESSARY UPSIZING OF POSTS, PICKETS AND HORIZONTAL BARS AND

INCREASING THE HEIGHT OF THE FENCE AS IT APPEARS IN THIS DETAIL AT NO ADDITIONAL COST TO THE

INCLUDE ALL PRODUCT CUT SHEETS AS WELL AS INSTALLATION AND MANUFACTURING DETAILS.

12. CONCRETE FOOTING FOR POSTS SHALL BE 3X POST WIDTH. GATE IS TO BE SELF CLOSING. FALCON

LEVERS. OUTSIDE LEVER IS LOCKED BY KEY IN OUTSIDE LEVER. INSIDE LEVER IS ALWAYS FREE. 13. POSTS SHALL BE PLACED AT A MINIMUM DISTANCE OF 6'-0" O.C. AND A MAXIMUM DISTANCE OF 7'-0" O.C.

15. LATCH SHALL BE SELF LATCHING, ON POOL SIDE OF ENCLOSURE AT A MIN. 42" ABOVE FINISH PAVING.

SHERWIN WILLIAMS PAINT CO., COLOR TO BE FLAT BLACK. CONTRACTOR TO SUBMIT SAMPLES AS REQUIRED.

5. PROVIDE CONTINUOUS WELDS ALONG ALL EDGES OF FENCE MEMBERS. GRIND SMOOTH ALL WELDS.

HOT ROLLED STRUCTURAL STEEL 50,000 PSI TENSILE STRENGTH, 60,000 PSI YIELD STRENGTH.

The bike rack is composed of corrosion-resistant cast aluminum. Use as a stand-alone or arrange in groups. A standard U-lock can be used to meet Association of Pedestrian and Bicycle Professionals (APBP) guidelines for security and functionality. Aluminum is 100% recyclable. The base has predrilled .4" diameter holes for surface mounting to prevent movement.


Fade-resistant, powder coated cast aluminum components feature a state-of-the-art primer proven to prevent rusting. Treated components exceed the industry standard by 34% in testing by independent

See website or sales representative for color choices.

The bike rack ships fully assembled and ready for use. Surface mounting will require some assembly.

The product is virtually maintenance-free and requires only periodic cleaning with a sponge and a solution of mild detergent and water to remove surface dirt. Do not clean with solvent or petroleum base products.

20-year limited structural warranty with 7-year finish warranty against fading from the date of purchase. See full details on multi-year warranties for components at www.anovafurnishings.com/warranty.aspx.

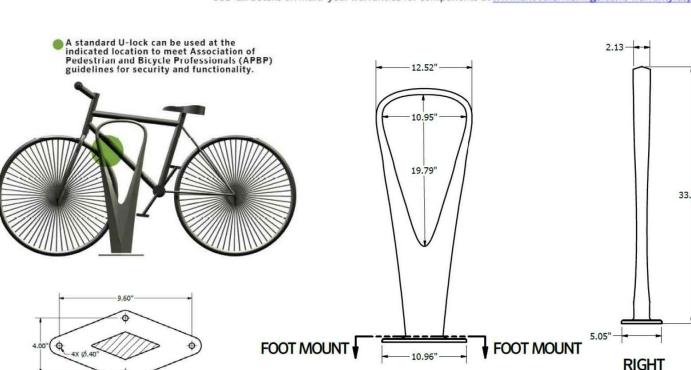

4.00" (4X	Ø.40"	•)	FOOT MOUNT	- 10	
	•			FR	
FOOT MOUNT			SHIPPING INFORMATIO		
it Weight	Unit Shipping Wt. UPS	Unit Shipping Wt. Truck	Unit Ship Size	Max Units	

Pallet Size/Wt. **Shipping Class** Per Pallet (32" x 48") (1-2 Units) 16 lbs./unit 9.56 cu. ft. 11/24/2015 Copyright 2016 ANOVA® Made in U.S.A

PARTIAL 8'-0" HT. WOOD FENCE SCALE: 3/4"=1'-0"

- 2" X 4" STRINGER (TYPICAL)

— 2-¾" DIA. GALV. POLE W/CAP

- 8" DIA. CONCRETE FOOTING

RESTRICTIVE MESH -

42" LATCH HT.-

6'-0" O.C. MIN

— 8'-0" MAX. POST SPACING ——

— 1" X 6" PICKETS (TYPICAL)

ORNAMENTAL METAL FENCE AND GATE

- 2" X 6" CAP

— 1" X 6" TRIM

7'-0" O.C. MAX.

TRILOGY LOCKING MECHANISM ON ALL GATES. —

USER CAN ACCESS THE POOL BY ENTERING IN THE

CODE FROM THE OUTSIDE OF THE SWIMMING POOL.

8" DIA. X 3' DEEP

CONCRETE FOOTING

PIPE SLEEVE WITH HIGH

STRENGTH NON-SHRINK

INSIDE LEVER IS ALWAYS FREE ALLOWING PEOPLE

INSIDE THE POOL ENCLOSURE TO EXIT FREELY.

8'-0" HT. WOOD FENCE

SCALE: 3/4"=1'-0"

BEVEL TOP OF FOOTING 1" MIN. FINISH GRADE

2-¾" DIA. GALV. POLE

2" X 4" STRINGER (4) - 1" X 4" PICKETS

- GALVANIZED POST CAP CONNECT POSTS TO RAILS WITH GALV. TWO PIECE

BRACKETS

- 1" X 6" TRIM

W/CAP


– 2" X 4" STRINGER

NOTE: CONTRACTOR SHALL

ENSURE THE MINIMUM DEPTH OF FENCE EMBEDMENT. ROCK MAY BE ENCOUNTERED.

8" DIA. CONCRETE FOOTING

MANUFACTURER SPECIFICATION SHEET

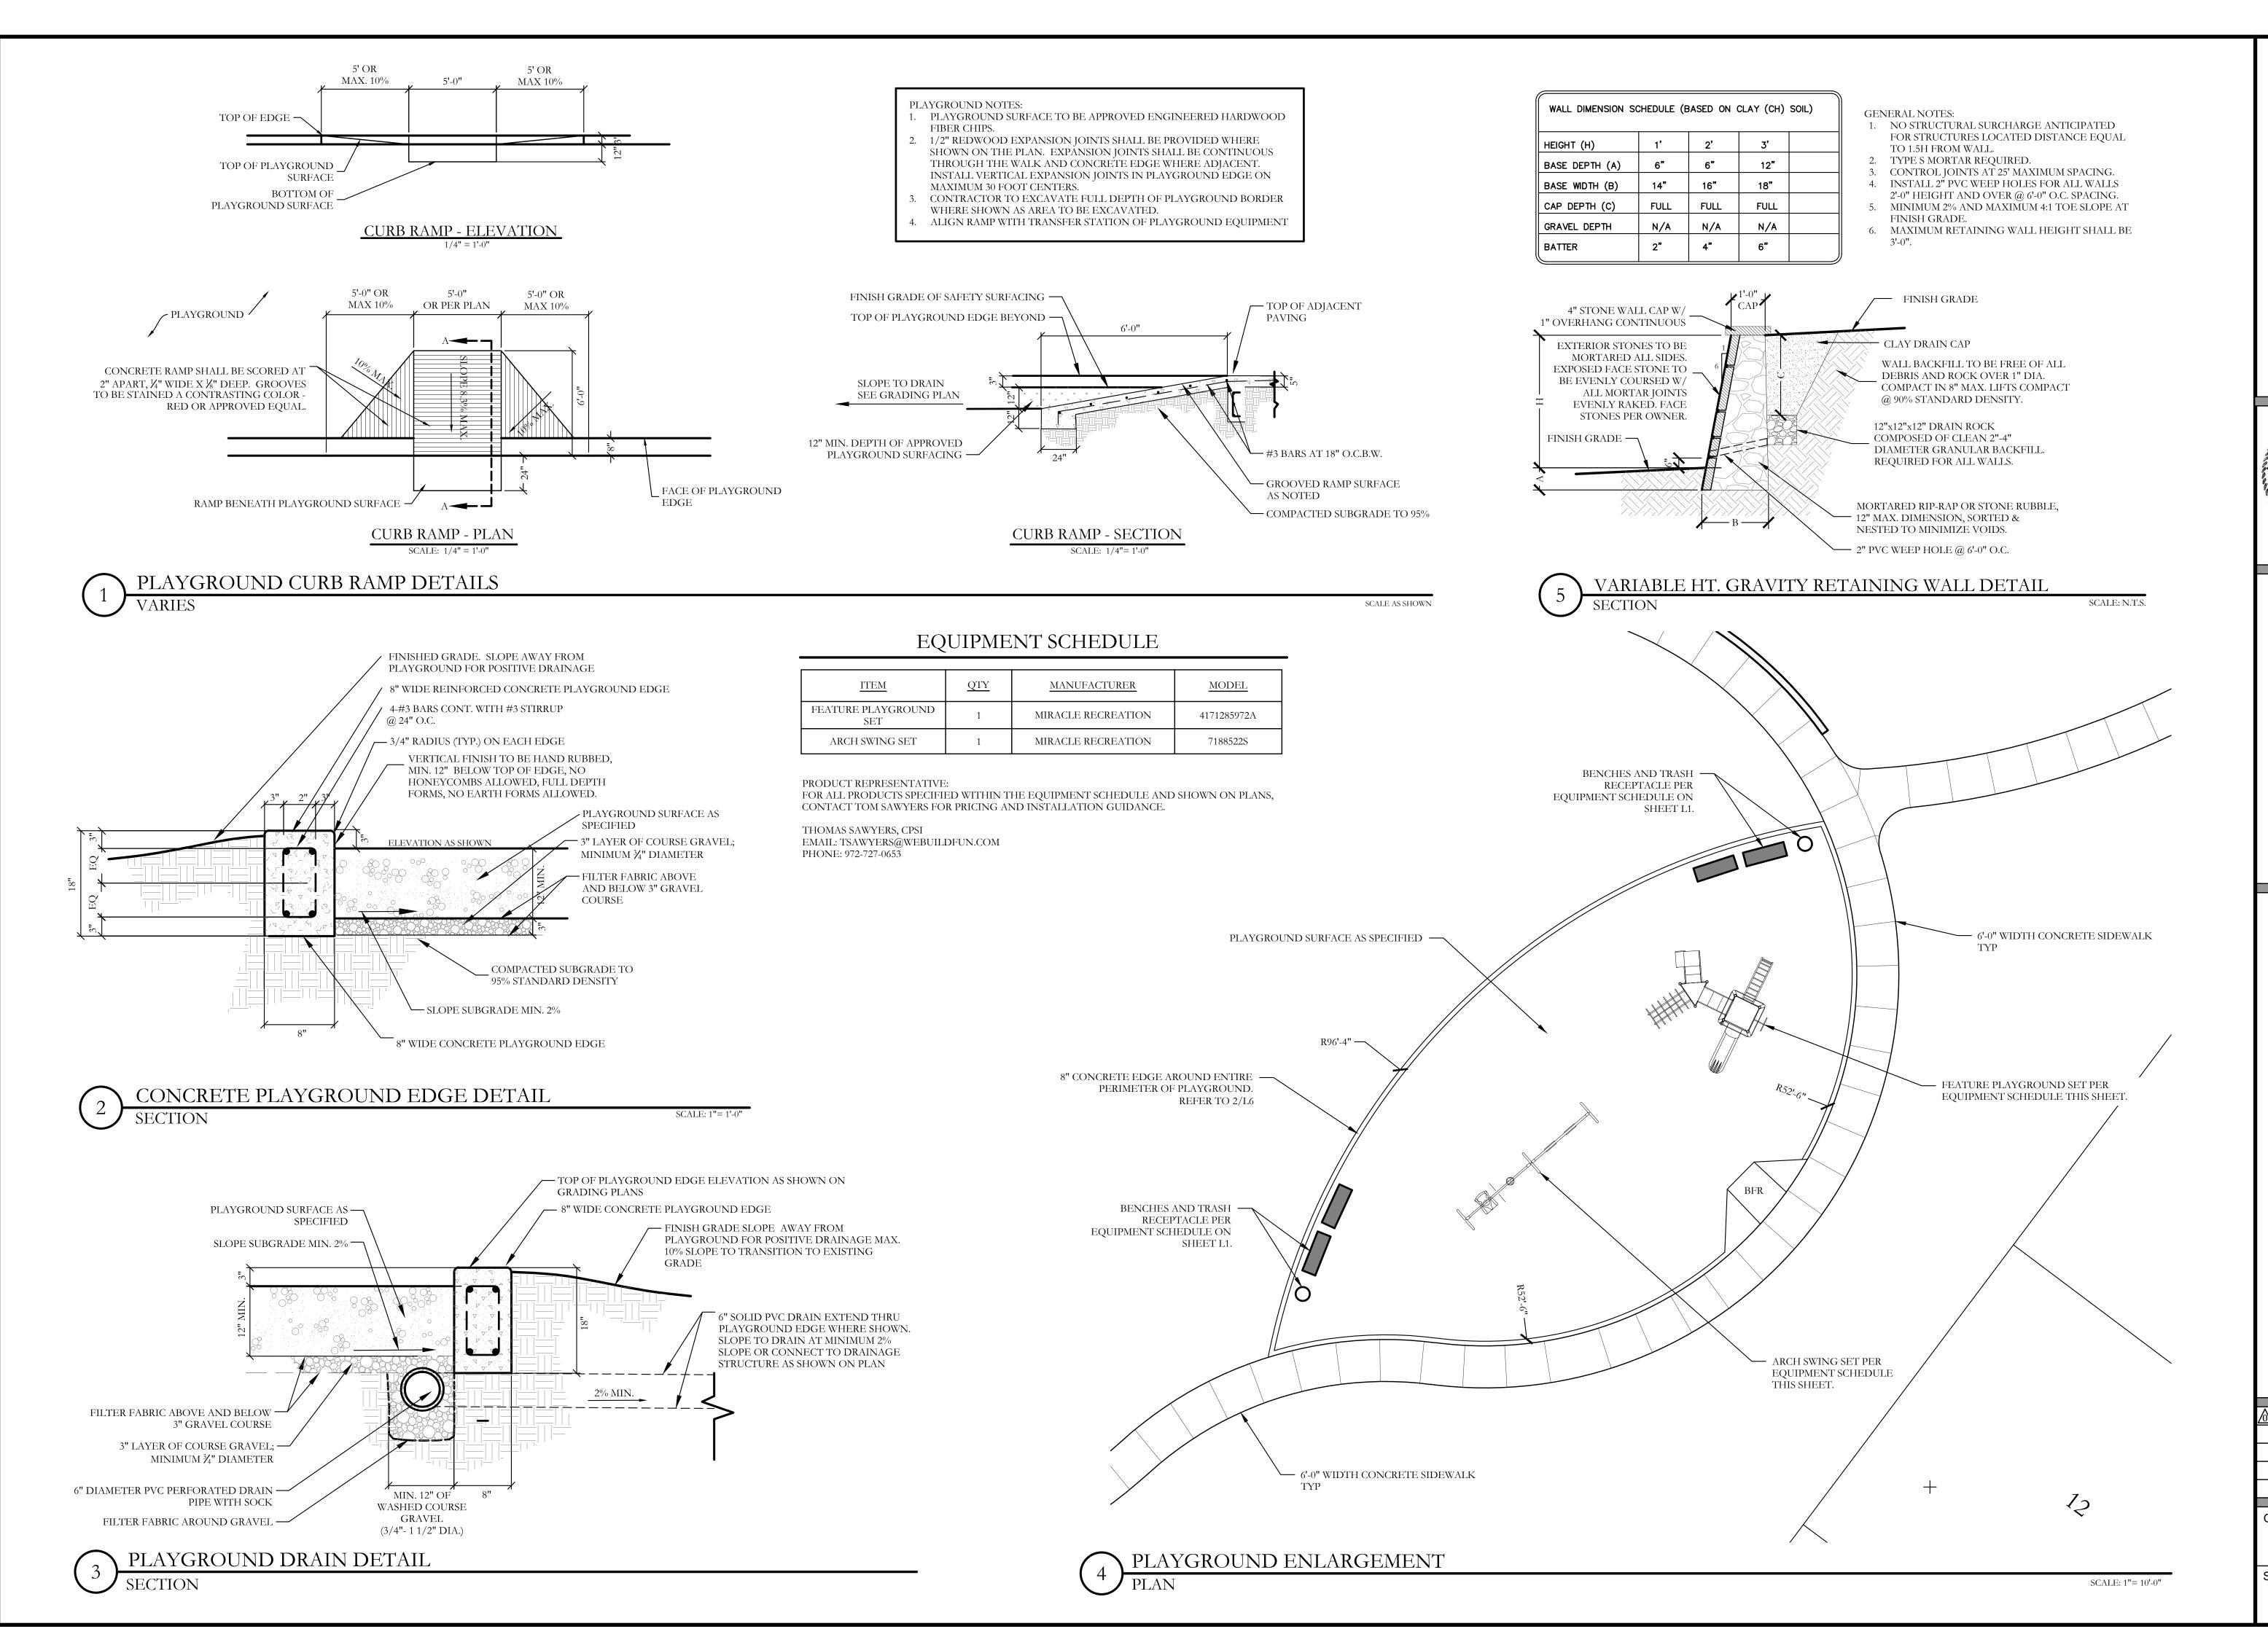

S RICHARD REAVES

REAVES REAVES CONSULTING 831 ARROWHEAD DRIVE PROSPER, TEXAS 75078 972.347.3908 F-10826

June 22, 2016

Bar is one inch on original drawing. If not one inch on this sheet, adjust scale as necessary.

CJS PROJECT NO. VIN003

SHEET NO.



The seat is 71.12" long and is composed of 12-gauge slotted steel with a .75" $\,$ gap slotted pattern. The seat is protected by Fusion Advantage™, a plastisol coating with an average .125" thickness and a high-gloss powder coat. The bench ends are cast iron and are protected by a fade resistant powder coat finish featuring a state of the art primer proven to prevent rusting. The bench is designed to be portable for flexibility in placement, and the legs have eet that can accommodate surface mounting to prevent movement. Mounting hardware is not included. The capacity of the bench is 200 lbs per linear foot.

> Fusion Advantage is a heat fused plastisol coating that creates an impervious rustproof barrier and resists UV deterioration, mildew, staining and fading. The finish has been tested to the requirements of ASTM E1354 and is determined to be in compliance with California Uniform Fire Code 1103.2.1.4.2. A state of the art primer is applied to all of the under supports, providing extreme rust fighting protection and durability. Treated components exceed the industry standard by 34% in testing by independant sources.

211 North Lindbergh Blvd.

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888.535.5005 tel


314.754.0835 fax

This product is available in the following vibrant colors: Black, Blue, Bronze, **RENDEZVOUS FLAT BENCH** Brown, Burgundy, Camel, Charcoal, Evergreen, Gray, Navy, Orange, Purple, Red, Sage, Silver, Teal, Vanilla, White, and Yellow. 6' slotted steel flat bench, portable/

The bench requires some assembly. Stainless steel assembly hardware is

included. The product is virtually maintenance-free and requires only periodic cleaning with a sponge and a solution of mild detergent and water to remove surface

dirt. Do not clean with solvent or petroleum based products. 20-year limited structural warranty with 7-year finish warranty from the date of purchase; Fusion Advantage components further warrants components will not rust, peel, chip, crack, mold or mildew for 7 years.

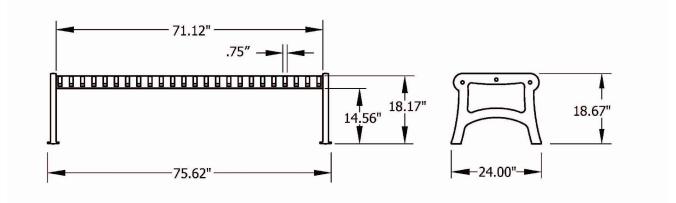

Unit Shipping Wt. Truck Unit Ship Size (1+ Units) W/Pallet Max Units per Pallet Wt. 84" x 36" Total No. Pkgs Shipping Class Unit Wt. Unit Shipping Wt. UPS

L1371

surface mount


PEDESTRIAN BENCH DETAIL





211 North Lindbergh Blvd. St. Louis, MO 63141 888.535.5005 tel 314.754.0835 fax specify@anovafurnishings.com anovafurnishings.com The table is 46.25" in diameter and features four contour swivel seats. The table top is 12-gauge steel and features a durable 1.5" square steel tube edge. The seats are 12-gauge slotted steel with a .75" gap slotted pattern and feature a reinforced frame connection. The seats swivel 90 degrees to each side for ease of entry and exit and are designed to automatically return to their original position. The table top and seats are protected by Fusion Advantage™, a plastisol coating with an average .125" thickness and a high-gloss powder coat. The table also features a 1.64" diameter umbrella hole in the center with a built-in umbrella holder. The table top is designed to support 100 lbs per square foot and the seats will support 200 lbs per linear foot. The frame and legs are made of 2.38" O.D. steel tubing protected by a fade resistant powder coat finish featuring a state of the art primer proven to prevent rusting. The frame is portable in design allowing for flexibility in placement. The legs feature feet with predrilled holes for surface mounting to prevent movement. Mounting hardware is not included. Fusion Advantage is a heat fused plastisol coating that creates an impervious **RENDEZVOUS TABLE** rustproof barrier and resists UV deterioration, mildew, staining and fading. 46" diameter steel table, 4 contour The finish has been tested to the requirements of ASTM E1354 and is determined to be in compliance with California Uniform Fire Code 1103.2.1.4.2. swivel seats, portable mount A state of the art primer is applied to all of the under supports, providing extreme rust fighting protection and durability. Treated components exceed the industry standard by 34% in testing by independant sources. 9' Standard Color Umbrella
9' Premium Color Umbrella
9' Premium Color Umbrella This product is available in the following vibrant colors: Black, Blue, Bronze, Brown, Burgundy, Camel, Charcoal, Evergreen, Gray, Navy, Orange, Purple, Red, Sage, Silver, Teal, Vanilla, White, and Yellow. The table requires some assembly. Stainless steel assembly hardware is included. The product is virtually maintenance-free and requires only periodic cleaning with a sponge and a solution of mild detergent and water to remove surface dirt. Do not clean with solvent or petroleum based products. 20-year limited structural warranty with 7-year finish warranty from the date of purchase; Fusion Advantage components further warrants components will not rust, peel, chip, crack, mold or mildew for 7 years. Unit Shipping Wt. Truck (1+ Units) Unit Wt. Unit Shipping Wt. UPS 327 lbs Made in USA Copyright © 2013 ANOVA™

TABLE DETAIL MANUFACTURER SPECIFICATION SHEET

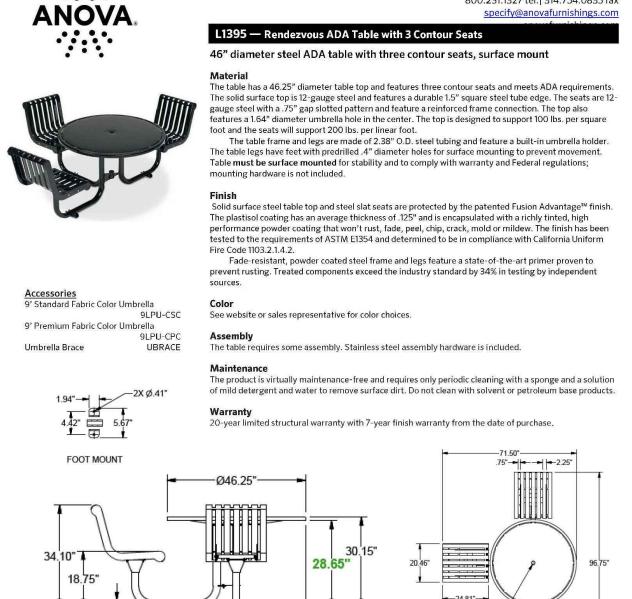

SHIPPING INFORMATION

w/Pallet

42 cu. ft.

Wt. Truck (1+ Units)


Max Units


Per Pallet

Pallet Size/Wt.

(48" x 48")

50 lbs.

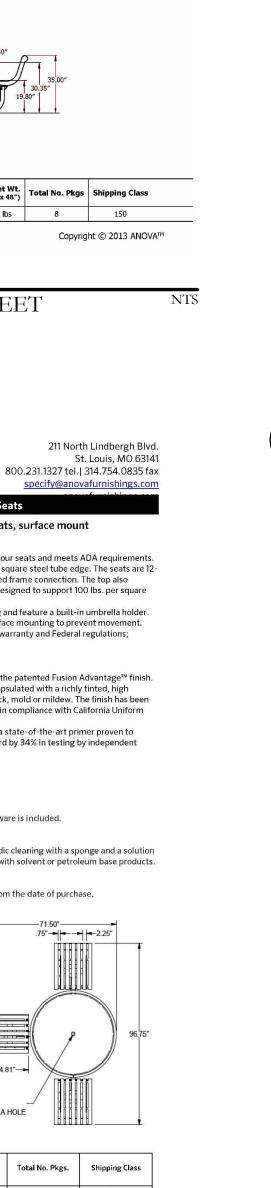


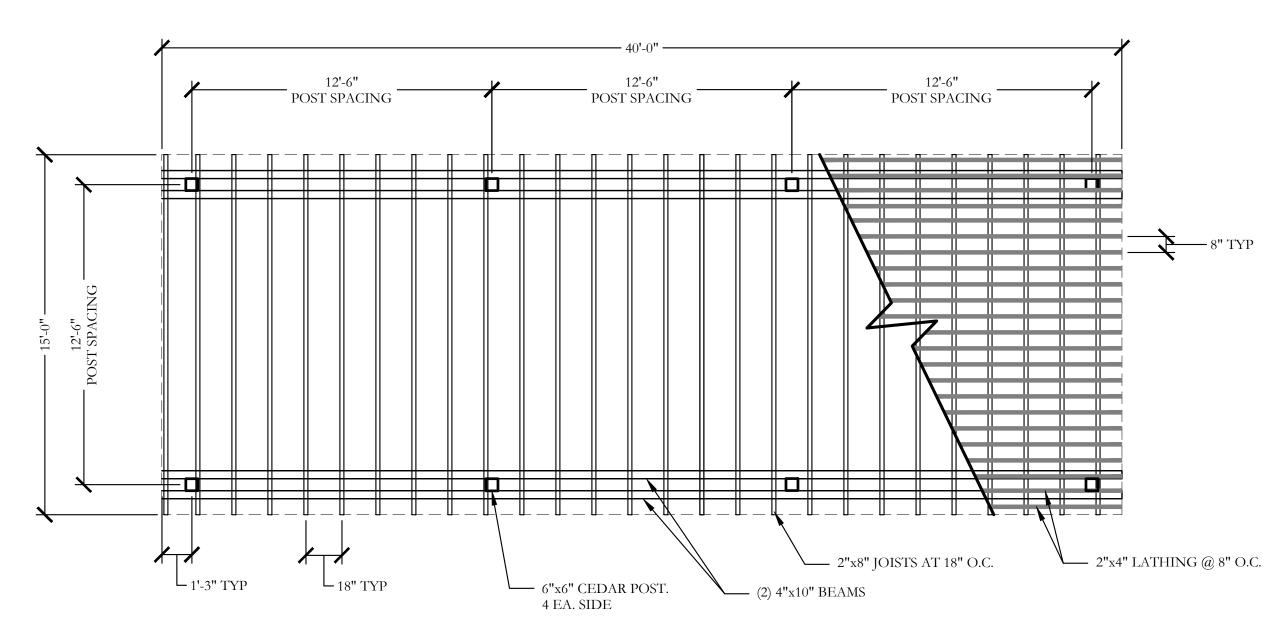


CEDAR SHADE STRUCTURE LAYOUT (15'x40')

SCALE: 1/4'' = 1'-0

SCALE: 1/4'' = 1'-0'

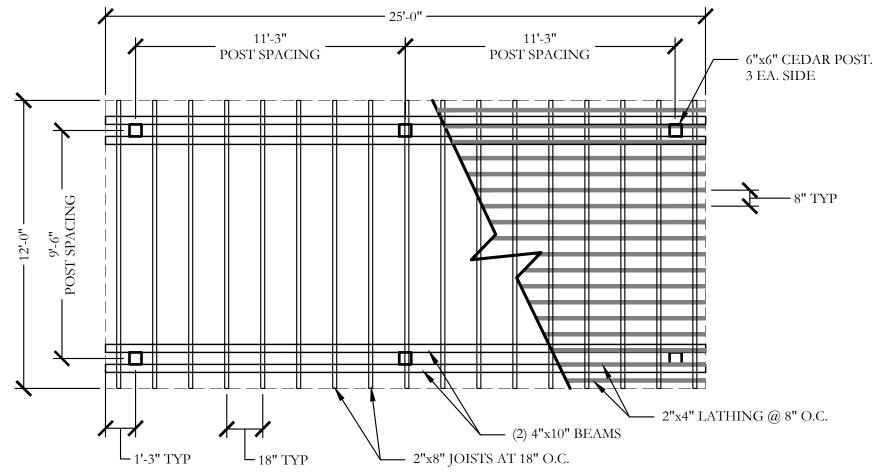

CEDAR SHADE STRUCTURE LAYOUT (12'x25')

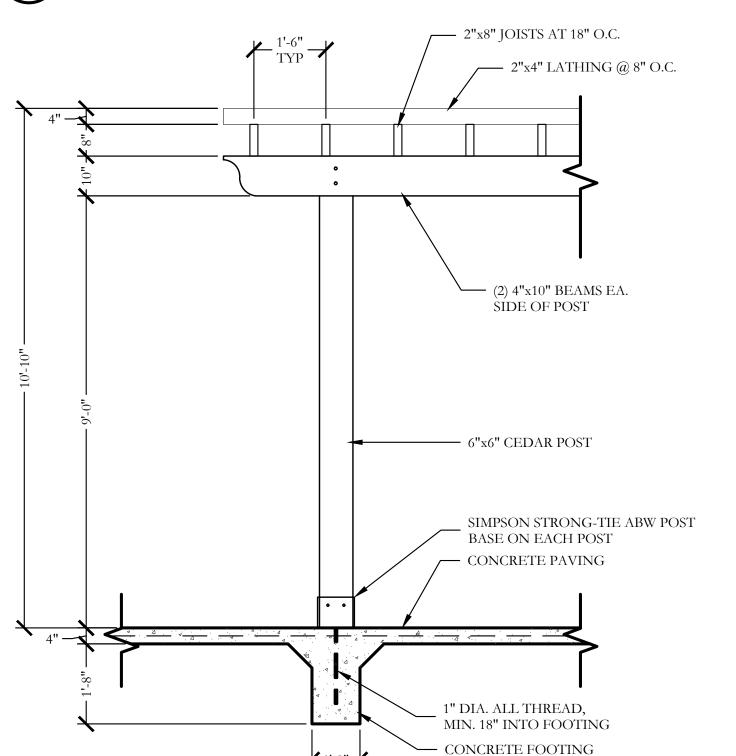

EDAR SHADE STRUCTURE DETAILS

CEDAR SHADE STRUCTURE NOTES

1. THE CONTRACTOR IS RESPONSIBLE FOR MAKING HIMSELF FAMILIAR WITH ALL UNDERGROUND UTILITIES, PIPES, AND STRUCTURES EITHER SHOWN OR NOT SHOWN ON THE PLANS. THE CONTRACTOR WILL BE RESPONSIBLE FOR ANY COST INCURRED DUE TO DAMAGE OR REPLACEMENT OF SAID UTILITIES AND STRUCTURES CAUSED BY HIS FORCES VERIFY LOCATION OF ALL UTILITIES WITH THE CITY AND VARIOUS UTILITY COMPANIES BEFORE DRILLING PIERS.

2. ALL CONCRETE USED IN FOOTINGS SHALL HAVE A MINIMUM COMPRESSIVE

STRENGTH OF 3,000 PSI @ 28 DAYS. 3. THE CONTRACTOR IS RESPONSIBLE FOR ALL NECESSARY AND REQUIRED PERMITS AND INSPECTIONS. CONSTRUCTION SHALL BE IN ACCORDANCE WITH CITY OF FRISCO CODES AND REQUIREMENTS.

4. WOOD MATERIAL FOR FENCE 4.1. JOIST-CEDAR, #2 GRADE OR BETTER.


4.2. BEAM-CEDAR, #2 GRADE OR BETTER. 4.3. POST- CEDAR, #2 GRADE OR, BETTER

5. ALL FASTENERS, NAILS, BRACKETS, STEEL POSTS, ETC.. ARE TO BE HOT

DIPPED GALVANIZED. 6. ACCURATELY CUT, FIT FASTEN MEMBERS, MAKE PLUMB, LEVEL, TRUE, AND RIGID. DO NOT SPLICE INDIVIDUAL FRAMING MEMBERS BETWEEN SUPPORTS. ERECT FACES OF FRAMING MEMBERS IN STRAIGHT EVEN PLANES TO RECEIVE FINISH MATERIALS. REMOVE ALL MARKS, STAMPS,

DIRT, LOOSE FIBERS FROM ALL WOOD SURFACES. 7. CONTRACTOR IS RESPONSIBLE FOR OBTAINING ALL REQUIRED PERMITS.

2"x8" JOISTS AT 18" O.C.

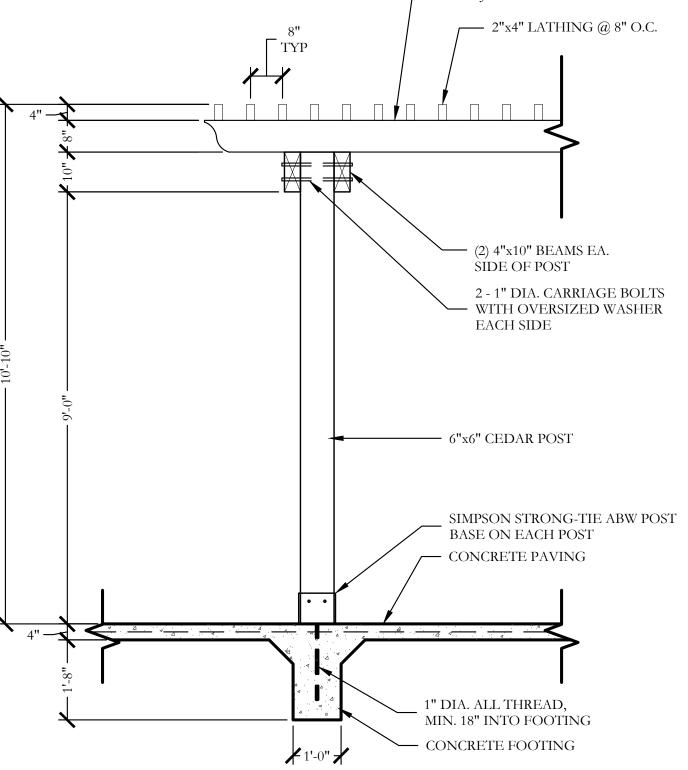

SCALE: 1/2'' = 1'-0''

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Bar is one inch on original drawing. If not one inch on this sheet, adjust scale as necessary.

Site

CJS PROJECT NO. VIN003 SHEET NO.

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